Airports Division


DEPARTMENT OF TRANSPORTATION STATE OF HAWAII


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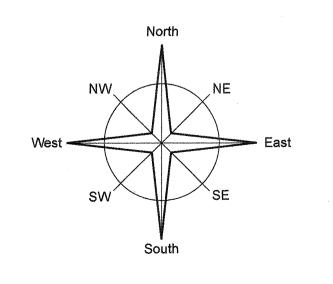
APRON IMPROVEMENTS


AT


ELLISON ONIZUKA KONA INTERNATIONAL AIRPORT AT KEAHOLE KAILUA-KONA, HAWAII PROJECT NO. AH2023-17




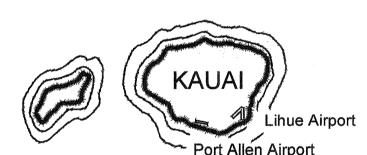

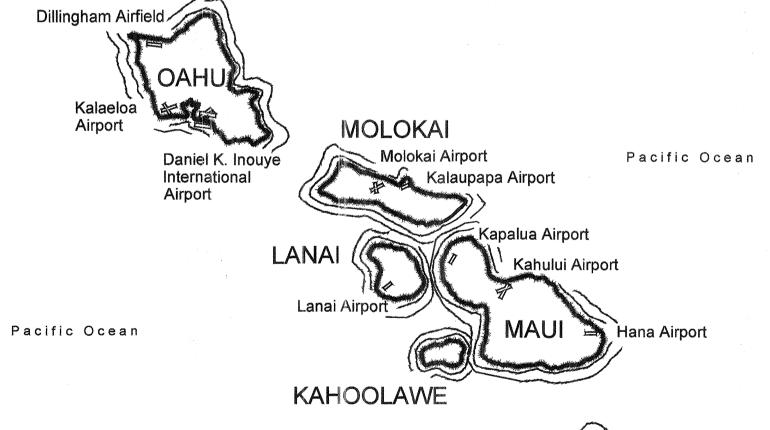

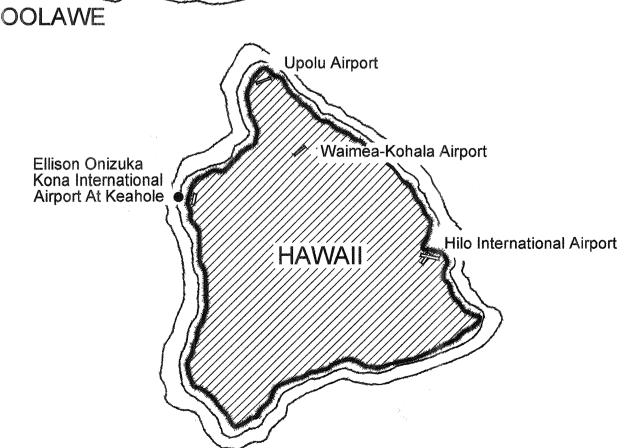

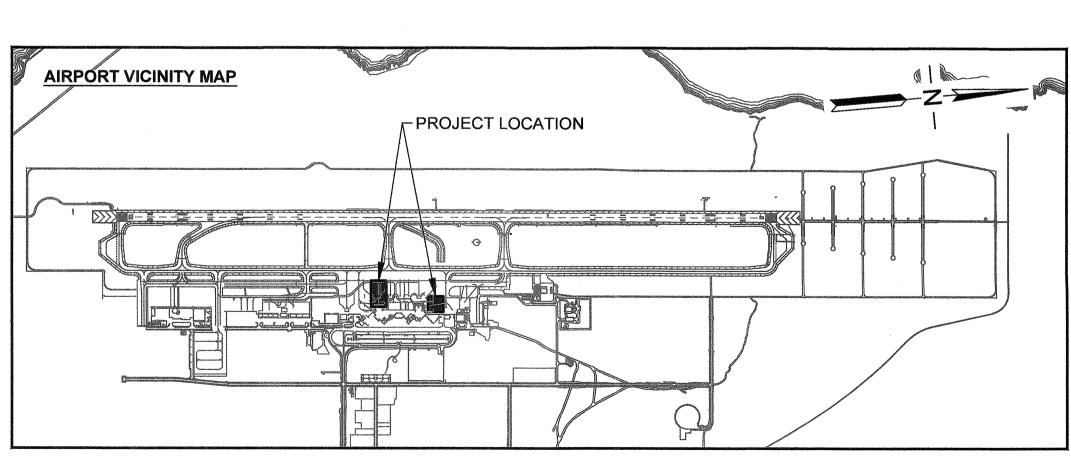

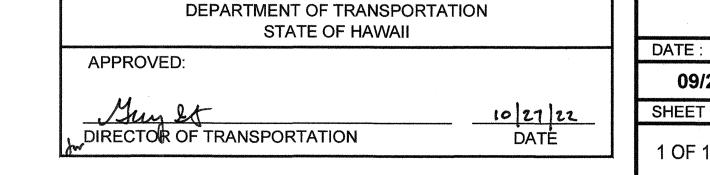


PROJECT TEAM

ORION ENGINEERS & ASSOCIATES 1003 BISHOP STREET, SUITE 2020








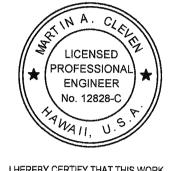

DSGN.	DRWN.	CHKD.	APPD.
AC	AT	TR	SH

KEY PLAN / NOTES:

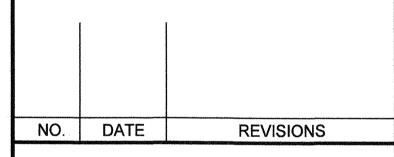

CONSTRUCTION **DOCUMENTS SEPTEMBER 23, 2022**

PROJECT TITLE:

APRON IMPROVEMENTS

AT ELLISON ONIZUKA KONA INTERNATIONAL AIRPORT AT KEAHOLE KAILUA-KONA, HAWAII

PROJECT NO .:

AH2023-17

SHEET TITLE:

TITLE SHEET, PROJECT LOCATION, & AIRPORT VICINITY MAP

TE:	DW	
09/23/2022		
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1 OF 12 SHEETS

G-101

INDEX OF DRAWINGS			
SHEET NUMBER	DRAWING NO	SHEET TITLE	
1	G-101	TITLE SHEET, PROJECT LOCATION, & AIRPORT VICINITY MAP	
2	G-102	INDEX OF DRAWINGS, ABBREVATIONS, AND NOTES	
3	G-103	CONSTRUCTION PHASING PLAN	
4	G-104	EROSION CONTROL PLAN AND DETAILS	
5	C-101	EXISTING CONDITIONS AND DEMOLITION PLAN 1	
6	C-102	EXISTING CONDITIONS AND DEMOLITION PLAN 2	
7	C-103	PAVING LAYOUT PLAN 1	
8	C-104	PAVING LAYOUT PLAN 2	
9	C-105	PAVEMENT SECTION	
10	C-106	PAVING DETAILS	
11	C-107	PAVEMENT MARKING PLAN	
12	C-108	PAVEMENT MARKING DETAILS	

SHEET NUMBERING SCHEME

ALL SHEETS WILL BE NUMBERED BEGINNING WITH A LETTER FOLLOWED BY A NUMBER AS FOLLOWS:

X-0

SEQUENTIAL DRAWING NO - DISCIPLINE LETTER KEY G - TITLE, GENERAL

C - CIVIL

DESIGNATED BY A NUMBER TITLE SCALE: 1"=10'-0" C-X C-X SHEET NUMBER WHERE **DETAIL/SECTION IS SHOWN** SHEET NUMBER FROM WHICH DETAIL/SECTION IS REFERENCED

LETTER AND DETAILS

SECTIONS DESIGNATED BY A

ABBRE\	<u>VIATION</u>	MH	MANHOLE
AC	ASPHALT CONCRETE	MIN	MINIMUM
ADG	AIRPLANE DESIGN GROUP	MPH	MILES PER HOUR
AGG	AGGREGATE	N	NORTH
AOA	AIRPORT OPERATIONS AREA	NAVAID	NAVIGATIONAL AID
APPROX	APPROXIMATE	NO	NUMBER
ARFF	AIRPORT RESCUE FIRE FIGHTING	NOTAM	NOTICE TO AIRMEN
ASTM	AMERICAN SOCIETY FOR TESTING AND MATERIALS	NTP	NOTICE TO PROCEED
ATCT	AIRPORT TRAFFIC CONTROL TOWER	NTS	NOT TO SCALE
BL	BASELINE	OC	ON CENTER
BMP	BEST MANAGEMENT PRACTICE	OD	OUTSIDE DIAMETER
CL	CENTER LINE	OFF	OFFSET
CONC	CONCRETE	PCC	PORTLAND CEMENT CONCRETE
CSO	CONTRACTOR SECURITY OFFICER	PROP	PROPOSED
CSPP	CONSTRUCTION SAFETY AND PHASING PLAN	QA	QUALITY ASSURANCE
CY	CUBIC YARD	RAD	RADIUS
DI	DRAIN INLET	REF	REFERENCE
DIA	DIAMETER	RON	REMAIN OVERNIGHT
DOH	DEPARTMENT OF HEALTH	RPR	RESIDENT PROJECT REPRESENTATIVE
DPW	DEPARTMENT OF PUBLIC WORKS	RT	RIGHT
DWG	DRAWING(S)	RWY	RUNWAY
E	EAST	S	SOUTH
= EA	EACH	SD	STORM DRAIN
ELEC	ELECTRIC	SECT	SECTION
ELEV	ELEVATION	SF	SQUARE FEET
EW	EACH WAY	SIDA	SECURITY IDENTIFICATION DISPLAY AR
EX	EXISTING	SPCD	SAFETY PLAN COMPLIANCE DOCUMENT
FAA	FEDERAL AVIATION ADMINISTRATION	SPEC	SPECIFICATIONS
FG	FINISH GRADE	SQ	SQUARE
FOD	FOREIGN OBJECT DEBRIS	ST	STREET
FPS	FEET PER SECOND	STA	STATION
FT	FEET	STD, STND	STANDARD
HDOT	HAWAII DEPARTMENT OF TRANSPORTATION	SY	SQUARE YARD
HMA	HOT MIX ASPHALT	TEMP	TEMPORARY
HORZ	HORIZONTAL	TOFA	TAXIWAY OBJECT FREE AREA
HRS	HOURS	TSA	TAXIWAY SAFETY AREA
INV		TWY	TAXIWAY
L	INVERT	TXL	TAXILANE
LAT	LENGTH	TYP	TYPICAL
LA I LB	LATITUDE	VERT	VERTICAL
	POUND	VSR	VEHICLE SERVICE ROAD
LF . .	LINEAR FEET	W	WEST
LONG	LEFT	W/	WITH
LONG	LONGITUDE	YR	YEAR
MAX	MAXIMUM	%	PERCENT
MBX	METAL BOX	, •	LITOLITI

GENERAL NOTES

- THIS PROJECT SHALL BE CONSTRUCTED IN ACCORDANCE WITH THE CONTRACT PLANS AND SPECIFICATIONS AND ANY RULES, REGULATIONS, STANDARDS OR SPECIFICATIONS REFERENCED THEREIN. THE PROJECT IS SUBJECT TO INSPECTION BY REPRESENTATIVES OF THE HAWAII DEPARTMENT OF TRANSPORTATION AIRPORTS DIVISION (HDOT-A), THE FEDERAL AVIATION ADMINISTRATION (FAA) AND OTHER GOVERNING AGENCIES.
- 2. LIQUIDATED DAMAGES. AS STATED IN THE CONTRACT AND CONSTRUCTION DOCUMENTS, SHALL APPLY TO THIS PROJECT
- THIS PROJECT REQUIRES CONSTRUCTION ON OR NEAR ACTIVE AIRPORT FACILITIES. ALL CONSTRUCTION ACTIVITIES SHALL BE CONDUCTED IN A MANNER ACCEPTABLE TO HDOT-A, AIRPORT OPERATIONS, AND THE FAA.
- 4. THE CONTRACTOR IS HEREBY NOTIFIED THAT THE FAA ASSESSES PENALTIES AND FINES FOR INCURSIONS INTO ANY PART OF THE AIRPORT THAT IS NOT OTHERWISE AUTHORIZED BY THE RESIDENT PROJECT REPRESENTATIVE (RPR) AND AIRPORT OPERATIONS. ALL SUCH PENALTIES AND FINES RESULTING FROM CONTRACTOR'S OPERATIONS SHALL BE PAID FOR AT THE CONTRACTOR'S EXPENSE. REPEATED OFFENSES MAY RESULT IN INDIVIDUAL DISBARMENT OF THE CONTRACTOR'S PERSONNEL.
- 5. THE PRIME CONTRACTOR SHALL HAVE A JOB SUPERINTENDENT ON SITE AT ALL TIMES WHILE WORK IS IN PROGRESS.
- 6. ALL PERSONNEL SHALL CLEAR THE CONSTRUCTION AREA AT THE END OF THE WORK SHIFT. ALL MECHANICS NEEDING ACCESS TO THE AOA DURING EVENINGS AND WEEKENDS TO WORK ON CONSTRUCTION EQUIPMENT SHALL BE ESCORTED AND HAVE THEIR VEHICLES IDENTIFIED WITH THE CONTRACTOR'S NAME AND APPROPRIATE LIGHTING.
- 7. MAXIMUM CONSTRUCTION TRAFFIC SPEED ON AIRPORT PROPERTY SHALL BE 15 MPH.
- 8. THE CONTRACTOR SHALL PERFORM ALL CONSTRUCTION IN STRICT ACCORDANCE WITH THE REQUIREMENTS OF THE APPROVED CONSTRUCTION SAFETY AND PHASING PLAN (CSPP). THE CONTRACTOR SHALL PREPARE A SAFETY PLAN COMPLIANCE DOCUMENT (SPCD) IN ACCORDANCE WITH FAA ADVISORY CIRCULAR AC-150/5370-2G "OPERATIONAL SAFETY ON AIRPORTS DURING CONSTRUCTION". THE SPCD SHALL DETAIL HOW THE CONTRACTOR WILL COMPLY WITH THE REQUIREMENTS OF THE APPROVED CSPP. THE SPCD SHALL BE APPROVED BY THE RPR PRIOR TO BEGINNING CONSTRUCTION.

CONTRACTOR'S GENERAL SECURITY AND OPERATIONAL REQUIREMENTS AND RESTRICTIONS

HOURS.

- THE CONTRACTOR SHALL COMPLY WITH ALL REQUIREMENTS OF THE AIRPORT SECURITY PLAN AND WITH THE SECURITY REQUIREMENTS SPECIFIED HEREIN. THE CONTRACTOR SHALL DESIGNATE TO THE CONSTRUCTION MANAGER AND AIRPORT OPERATIONS THE NAME OF ITS "CONTRACTOR SECURITY OFFICER" (CSO). THE CSO SHALL REPRESENT THE CONTRACTOR ON THE SECURITY REQUIREMENTS FOR THE CONTRACT. CSO SHALL BE ON SITE AT ALL TIMES DURING WORKING
- 2. CONTRACTOR PERSONNEL SECURITY ORIENTATION: THE CSO SHALL BE RESPONSIBLE FOR BRIEFING ALL CONTRACTOR PERSONNEL ON AIRPORT SECURITY REQUIREMENTS AND OTHER SECURITY PROVISIONS. ALL NEW CONTRACTOR EMPLOYEES SHALL BE BRIEFED ON THESE REQUIREMENTS PRIOR TO WORKING IN THE CONSTRUCTION AREA.
- 3. ALL CONTRACTOR PERSONNEL ENTERING THE AOA MUST BE PROPERLY BADGED PER THE PROJECT SPECIFICATIONS.
- 4. THE CONTRACTOR'S CSO WILL BE RESPONSIBLE FOR ALL OPERATIONAL PRECAUTIONS. PRIOR TO THE COMMENCEMENT OF THE WORK THE CSO SHALL PROVIDE THE RPR AND AIRPORT OPERATIONS AN OUTLINE OF A PROPOSED ACCIDENT AND FIRE PROTECTION PLAN FOR ALL WORK CONTEMPLATED UNDER THE CONTRACT AND CONDUCT AT LEAST ONE SAFETY MEETING EACH WEEK FOR EACH SHIFT AND REQUIRE THE ATTENDANCE OF ALL SUPERVISORS AT SUCH MEETINGS. COPIES OF THE MINUTES OF SAFETY MEETINGS SHALL BE KEPT ON FILE IN THE CONTRACTOR'S FIELD OFFICE AND MADE AVAILABLE UPON REQUEST TO THE RPR OR AIRPORT OPERATIONS.

CONTRACTOR ACCESS, STORAGE AREAS, AND HAUL ROUTES

- 1. LOCATION OF HAUL ROUTES AND STAGING AREAS AS SHOWN ON THE CONSTRUCTION PHASING PLANS ARE APPROXIMATE. IT SHALL BE THE CONTRACTOR'S RESPONSIBILITY TO COORDINATE EXACT LOCATIONS IN THE FIELD WITH THE RPR AND AIRPORT OPERATIONS, AND TO COORDINATE OFF-SITE HAUL ROUTES (STATE HIGHWAYS OR COUNTY ROADS) WITH THE APPROPRIATE OWNER HAVING JURISDICTION. ALL HAUL ROUTES AND STAGING AREAS SHALL BE MAINTAINED BY THE CONTRACTOR AND SHALL BE RESTORED TO THEIR ORIGINAL CONDITION UPON COMPLETION OF BEING USED AS A HAUL ROUTE. THE BEFORE AND AFTER CONDITION OF ON-SITE HAUL ROUTES AND STAGING AREAS SHALL BE JOINTLY INSPECTED AND DOCUMENTED BY THE CONTRACTOR, THE RPR, AND AIRPORT OPERATIONS. THE BEFORE AND AFTER CONDITION OF OFF-SITE HAUL ROUTES SHALL BE JOINTLY INSPECTED BY THE CONTRACTOR AND THE OWNER HAVING JURISDICTION. THE CONTRACTOR SHALL PROVIDE A VIDEO RECORDING OR DIGITAL PICTURES OF ALL HAUL ROUTES AND STAGING AREAS BEFORE START OF WORK AND UPON COMPLETION. FENCING, DRAINAGE, SEDIMENT CONTROL, GRADING AND OTHER MISCELLANEOUS CONSTRUCTION REQUIRED TO CONSTRUCT TEMPORARY HAUL ROUTES OR ACCESS POINTS ON THE AIRPORT SHALL BE THE CONTRACTOR'S TOTAL RESPONSIBILITY AND SHALL BE APPROVED BY THE RPR AND AIRPORT OPERATIONS PRIOR TO THE WORK. ALL ON-SITE ACCESS ROADS TO AIRPORT FACILITIES SHALL REMAIN OPEN AND MAINTAINED AT ALL
- 2. THE CONTRACTOR SHALL ONLY USE THE HAUL ROUTES APPROVED BY THE RPR AND AIRPORT OPERATIONS AND AS SHOWN ON THE CONSTRUCTION PHASING PLANS. THE HAUL TRUCKS MUST BE COVERED

- AT ALL TIMES. THE CONTRACTOR SHALL CONTINUOUSLY CLEAN THE HAUL ROUTE WITH A POWER VACUUM DURING WORKING HOURS. FOR UNPAVED PORTIONS OF THE HAUL ROUTES, THE CONTRACTOR SHALL IMPLEMENT BMP DUST CONTROL MEASURES AND PRACTICES TO PREVENT AIRBORNE DUST. FAILURE TO MAINTAIN THE HAUL ROUTE IN AN MANNER ACCEPTABLE TO THE RPR AND AIRPORT OPERATIONS WILL RESULT IN SUSPENSION OF WORK. IN THE EVENT THAT ANY FOREIGN OBJECT, SPILLAGE, DEBRIS OR DUST BUILDS UP AS A RESULT OF HAULING. THE CONTRACTOR SHALL IMMEDIATELY CLEAN AND REMOVE THE MATERIAL.
- ALL MATERIALS AND EQUIPMENT, WHEN NOT IN USE, SHALL BE MOVED TO THE CONTRACTOR'S STAGING AREA. ANY OTHER AREAS TO BE USED FOR STORAGE MUST BE APPROVED BY THE RPR AND AIRPORT OPERATIONS. EQUIPMENT AND STOCKPILED MATERIAL SHALL BE CONSTRAINED IN A MANNER ACCEPTABLE TO THE RPR AND AIRPORT OPERATIONS.
- THE CONTRACTOR'S ACCESS POINTS TO THE SITE SHALL BE AS SHOWN ON THE CONSTRUCTION PHASING PLANS. THE CONTRACTOR SHALL BE RESPONSIBLE TO MAINTAIN AIRPORT SECURITY FOR ALL VEHICLES AND PERSONNEL WHO ENTER AIRPORT PROPERTY.
- 5. ON-SITE EMPLOYEE PARKING SHALL BE ADDRESSED AT THE PRECONSTRUCTION CONFERENCE
- ALL CONTRACTOR'S VEHICLES SHALL BE IN GOOD WORKING ORDER. THE CONTRACTOR SHALL BE RESPONSIBLE FOR COORDINATING VEHICLE ACCESS TO THE AIRPORT WITH THE RPR AND AIRPORT OPERATIONS.
- ALL CONTRACTOR VEHICLES/EQUIPMENT THAT ARE AUTHORIZED TO OPERATE ON THE AIRPORT'S AOA SHALL DISPLAY IN FULL VIEW ABOVE THE VEHICLE/EQUIPMENT A FLAG/LIGHT FOR DAYTIME AND A LIGHT FOR NIGHTTIME. THE FLAG SHALL BE A 3'x3' (MIN) ORANGE AND WHITE CHECKER BOARD FLAG. EACH CHECKER BOARD COLOR BEING ONE SQUARE FOOT. ANY VEHICLE OPERATING ON THE AOA SHALL ALSO BE EQUIPPED WITH A FLASHING AMBER (YELLOW) DOME TYPE LIGHT, MOUNTED ON TOP OF THE VEHICLE AND OF SUCH INTENSITY TO CONFORM TO LOCAL AND FEDERAL CODES FOR MAINTENANCE AND EMERGENCY VEHICLES (DAY OR NIGHT OPERATIONS).
- THE CONTRACTOR SHALL FURNISH ALL ESCORTS, FLAGGERS, TRAFFIC CONTROL DEVICES, AND COMMUNICATION DEVICES SPECIFIED IN THE SPECIAL PROVISIONS AND THE SPECIFICATIONS.
- THE CONTRACTOR'S ESCORTS SHALL CONTINUOUSLY MONITOR RADIO FREQUENCY AS INDICATED IN THE APPROVED CSPP.
- 10. BEFORE STARTING EACH WORK SHIFT, THE CONTRACTOR SHALL SET UP ALL AOA TRAFFIC CONTROL DEVICES AS SHOWN ON THE PHASING PLANS. SET-UP SHALL BE IN THE ORDER REQUIRED BY THE CONTRACT OR AS DIRECTED BY AIRPORT OPERATIONS. THE CONTRACTOR SHALL TAKE DOWN ALL AOA TRAFFIC CONTROL DEVICES IN THE REVERSE ORDER.

UNDERGROUND UTILITIES

- THE CONTRACTOR SHALL LOCATE AND IDENTIFY ALL UNDERGROUND UTILITIES IN THE WORK AREA PRIOR TO CONSTRUCTION. ANY UNDERGROUND UTILITIES LOCATED WHICH DO NOT APPEAR ON THE PLANS SHALL BE BROUGHT TO THE ATTENTION OF THE RPR AND AIRPORT OPERATIONS. ANY DAMAGE TO UTILITIES, CAUSED BY THE CONTRACTOR, SHALL BE REPAIRED AT THE CONTRACTOR'S SOLE EXPENSE.
- UNLESS OTHERWISE SHOWN ON THE PLANS, THE CONTRACTOR SHALL PROTECT EXISTING AIRFIELD LIGHTING SYSTEMS, FAA NAVAIDS, WEATHER EQUIPMENT, AND OTHER AIRPORT FACILITIES DURING CONSTRUCTION OPERATIONS. ANY DAMAGE TO THESE FACILITIES OR UNDERGROUND CABLES SERVING THESE FACILITIES SHALL BE REPAIRED BY THE CONTRACTOR AS DIRECTED BY THE RPR, AIRPORT OPERATIONS, AND/OR THE FAA. ALL REPAIRS SHALL BE AT THE CONTRACTOR'S EXPENSE WHETHER PERFORMED BY CONTRACTOR PERSONNEL OR BY OTHERS
- THE CONTRACTOR SHALL NOTIFY, AT LEAST TWO WORKING DAYS PRIOR TO COMMENCING CONSTRUCTION OPERATIONS IN AN AREA WHICH MAY INVOLVE UNDERGROUND UTILITY FACILITIES, THE RPR AND AIRPORT OPERATIONS AND THE OWNER OF EACH UNDERGROUND UTILITY FACILITY SHOWN ON THE PLANS.
- THE CONTRACTOR SHALL REPORT IMMEDIATELY TO THE RPR, AIRPORT OPERATIONS, AND THE OPERATOR OF THE UNDERGROUND FACILITY ANY BREAK OR LEAK ON ITS LINES OR ANY DENT, GOUGE, GROOVE OR OTHER DAMAGE TO SUCH LINES OR THEIR COATING OR CATHODIC PROTECTION, MADE OR DISCOVERED IN THE COURSE OF THEIR EXCAVATION.
- ALL REQUIRED TEMPORARY UTILITIES INCLUDING POWER, WATER, AND SEWER FOR THE CONTRACTOR'S STAGING AREA SHALL BE ARRANGED AND PAID FOR BY THE CONTRACTOR. THE CONTRACTOR SHALL PROVIDE ALL POLES, LINES, PIPES, METERS, ETC. TO BRING THE SERVICE FROM EXISTING SOURCES TO THE AREA. ALL TEMPORARY UTILITY ARRANGEMENTS SHALL BE SUBJECT TO THE APPROVAL OF THE RPR AND AIRPORT OPERATIONS. UPON COMPLETION OF THE PROJECT, THE CONTRACTOR SHALL HAVE ALL UTILITIES DISCONNECTED AND SHALL REMOVE ALL POLES, PIPES, METERS, ETC. AND RESTORE THE AREAS TO THEIR PREVIOUS CONDITION.
- FOR ALL ITEMS REQUIRING THE USE OF WATER, THE CONTRACT UNIT PRICE BID FOR THE RESPECTIVE ITEM SHALL INCLUDE THE COST OF FURNISHING THE WATER.
- ANY UTILITIES DAMAGED OR BROKEN BY THE CONTRACTOR SHALL BE REPAIRED AND PUT BACK INTO WORKING ORDER IN A MANNER ACCEPTABLE TO THE OWNER OF THE AFFECTED UTILITY BY THE CONTRACTOR AT ITS EXPENSE.

CONTACT INFORMATION

HAWAII DOT PROJECT MANAGER: HANY SOKAR, 808-838-8848 AIRPORT MANAGER: CHAUNCEY WONG-YUEN, 808-327-9522



Airports Division EPARTMENT OF TRANSPORTATION STATE OF HAWAII



I HEREBY CERTIFY THAT THIS WORK WAS PREPARED BY ME OR UNDER MY

DSGN.	DRWN.	CHKD.	APPD.
AC	AT	TR	SH

KEY PLAN / NOTES:

NO. DATE **REVISIONS**

CONSTRUCTION **DOCUMENTS SEPTEMBER 23, 2022**

PROJECT TITLE:

APRON IMPROVEMENTS

ELLISON ONIZUKA KONA INTERNATIONAL AIRPORT AT KEAHOLE

KAILUA-KONA. HAWAII

PROJECT NO.:

AH2023-17

SHEET TITLE:

INDEX OF DRAWINGS, ABBREVATIONS, AND **NOTES**


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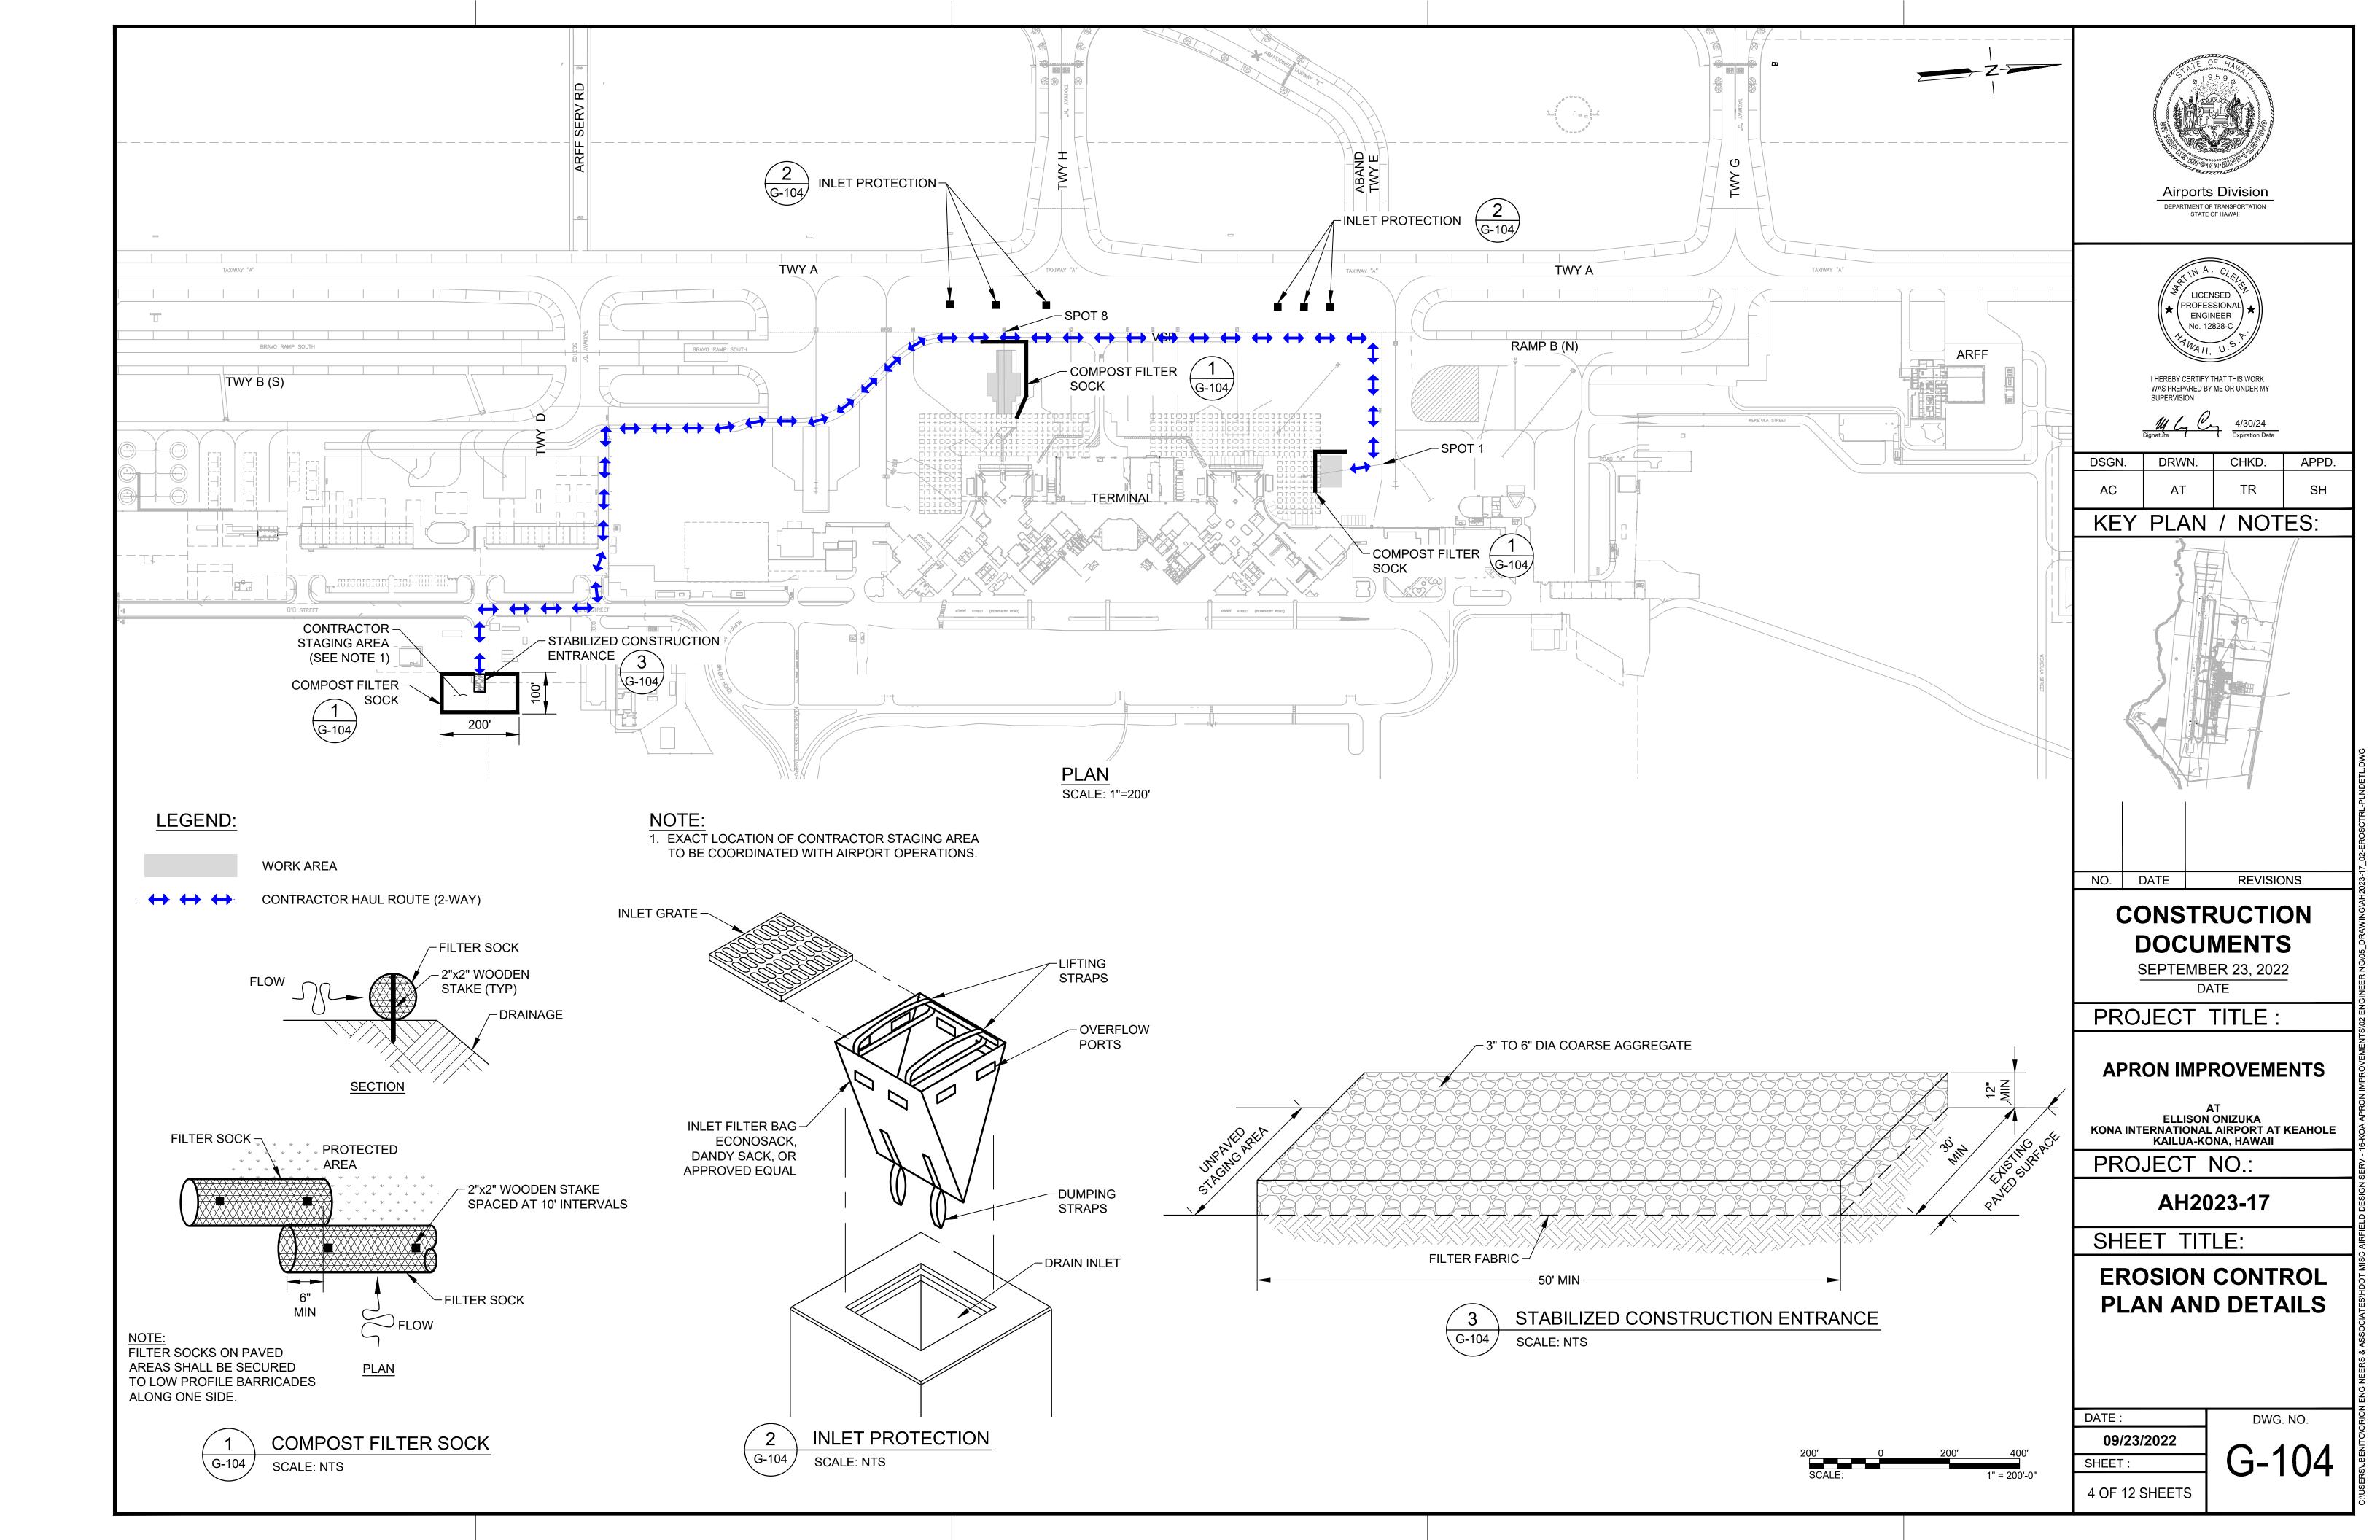
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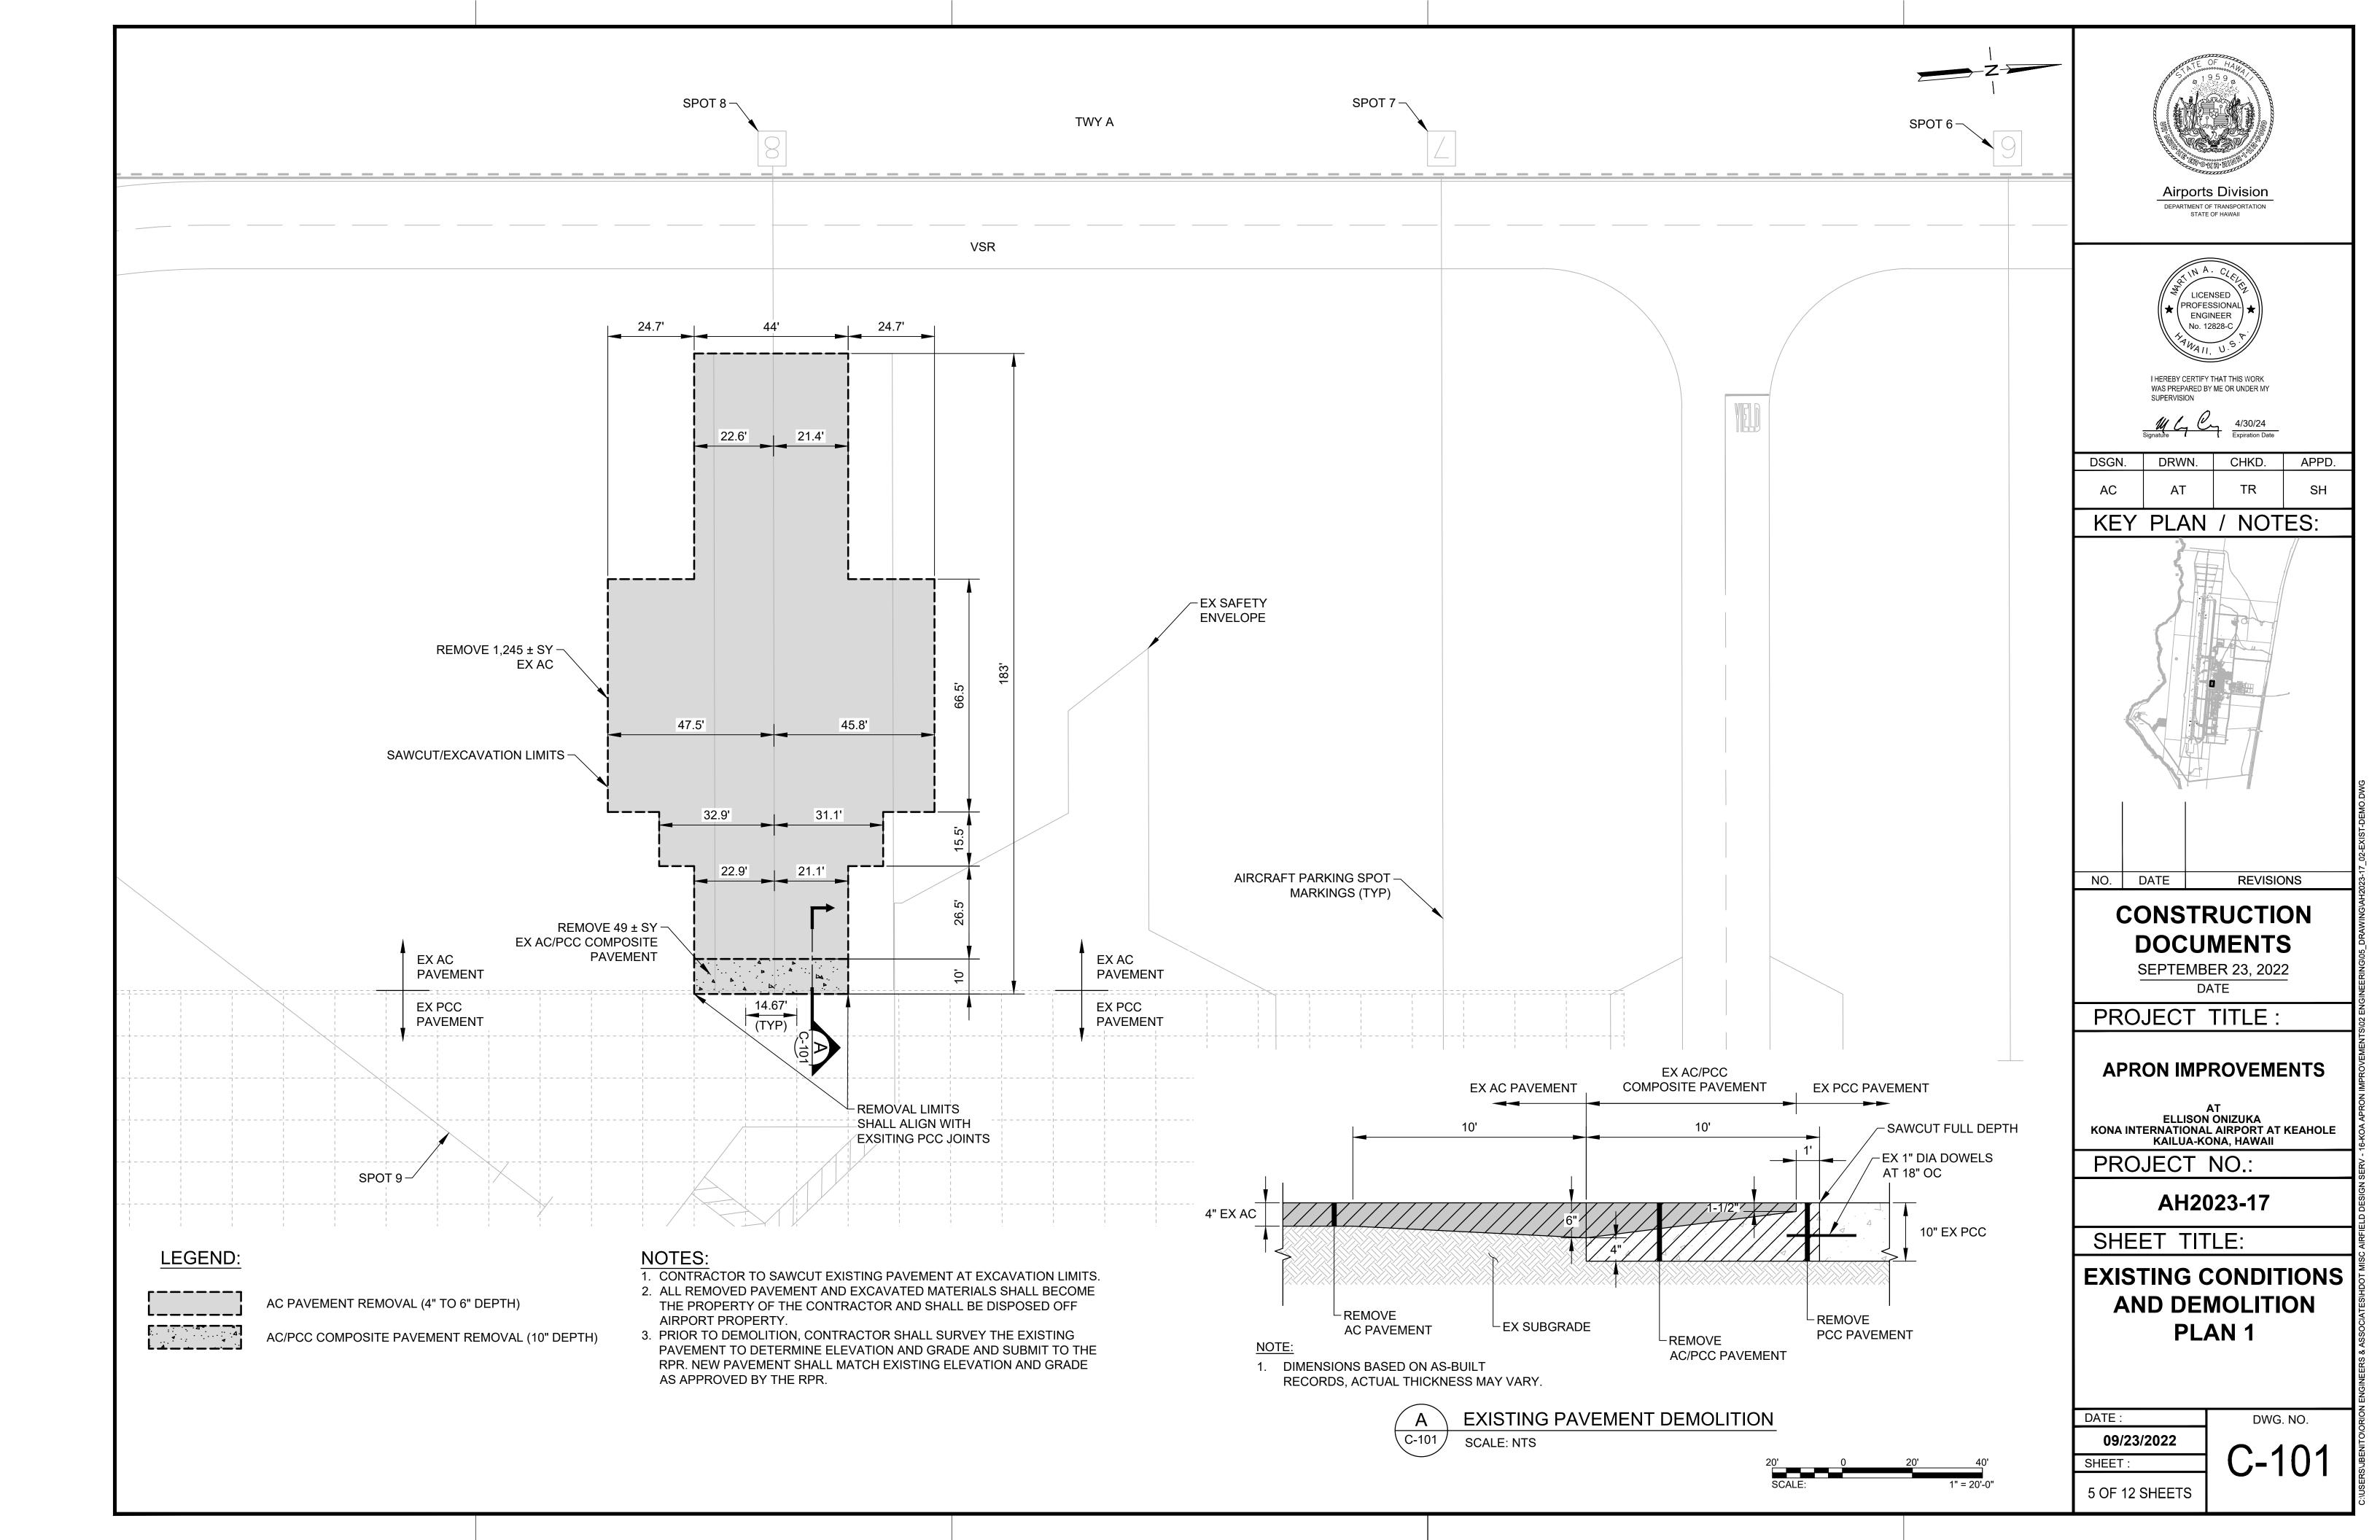
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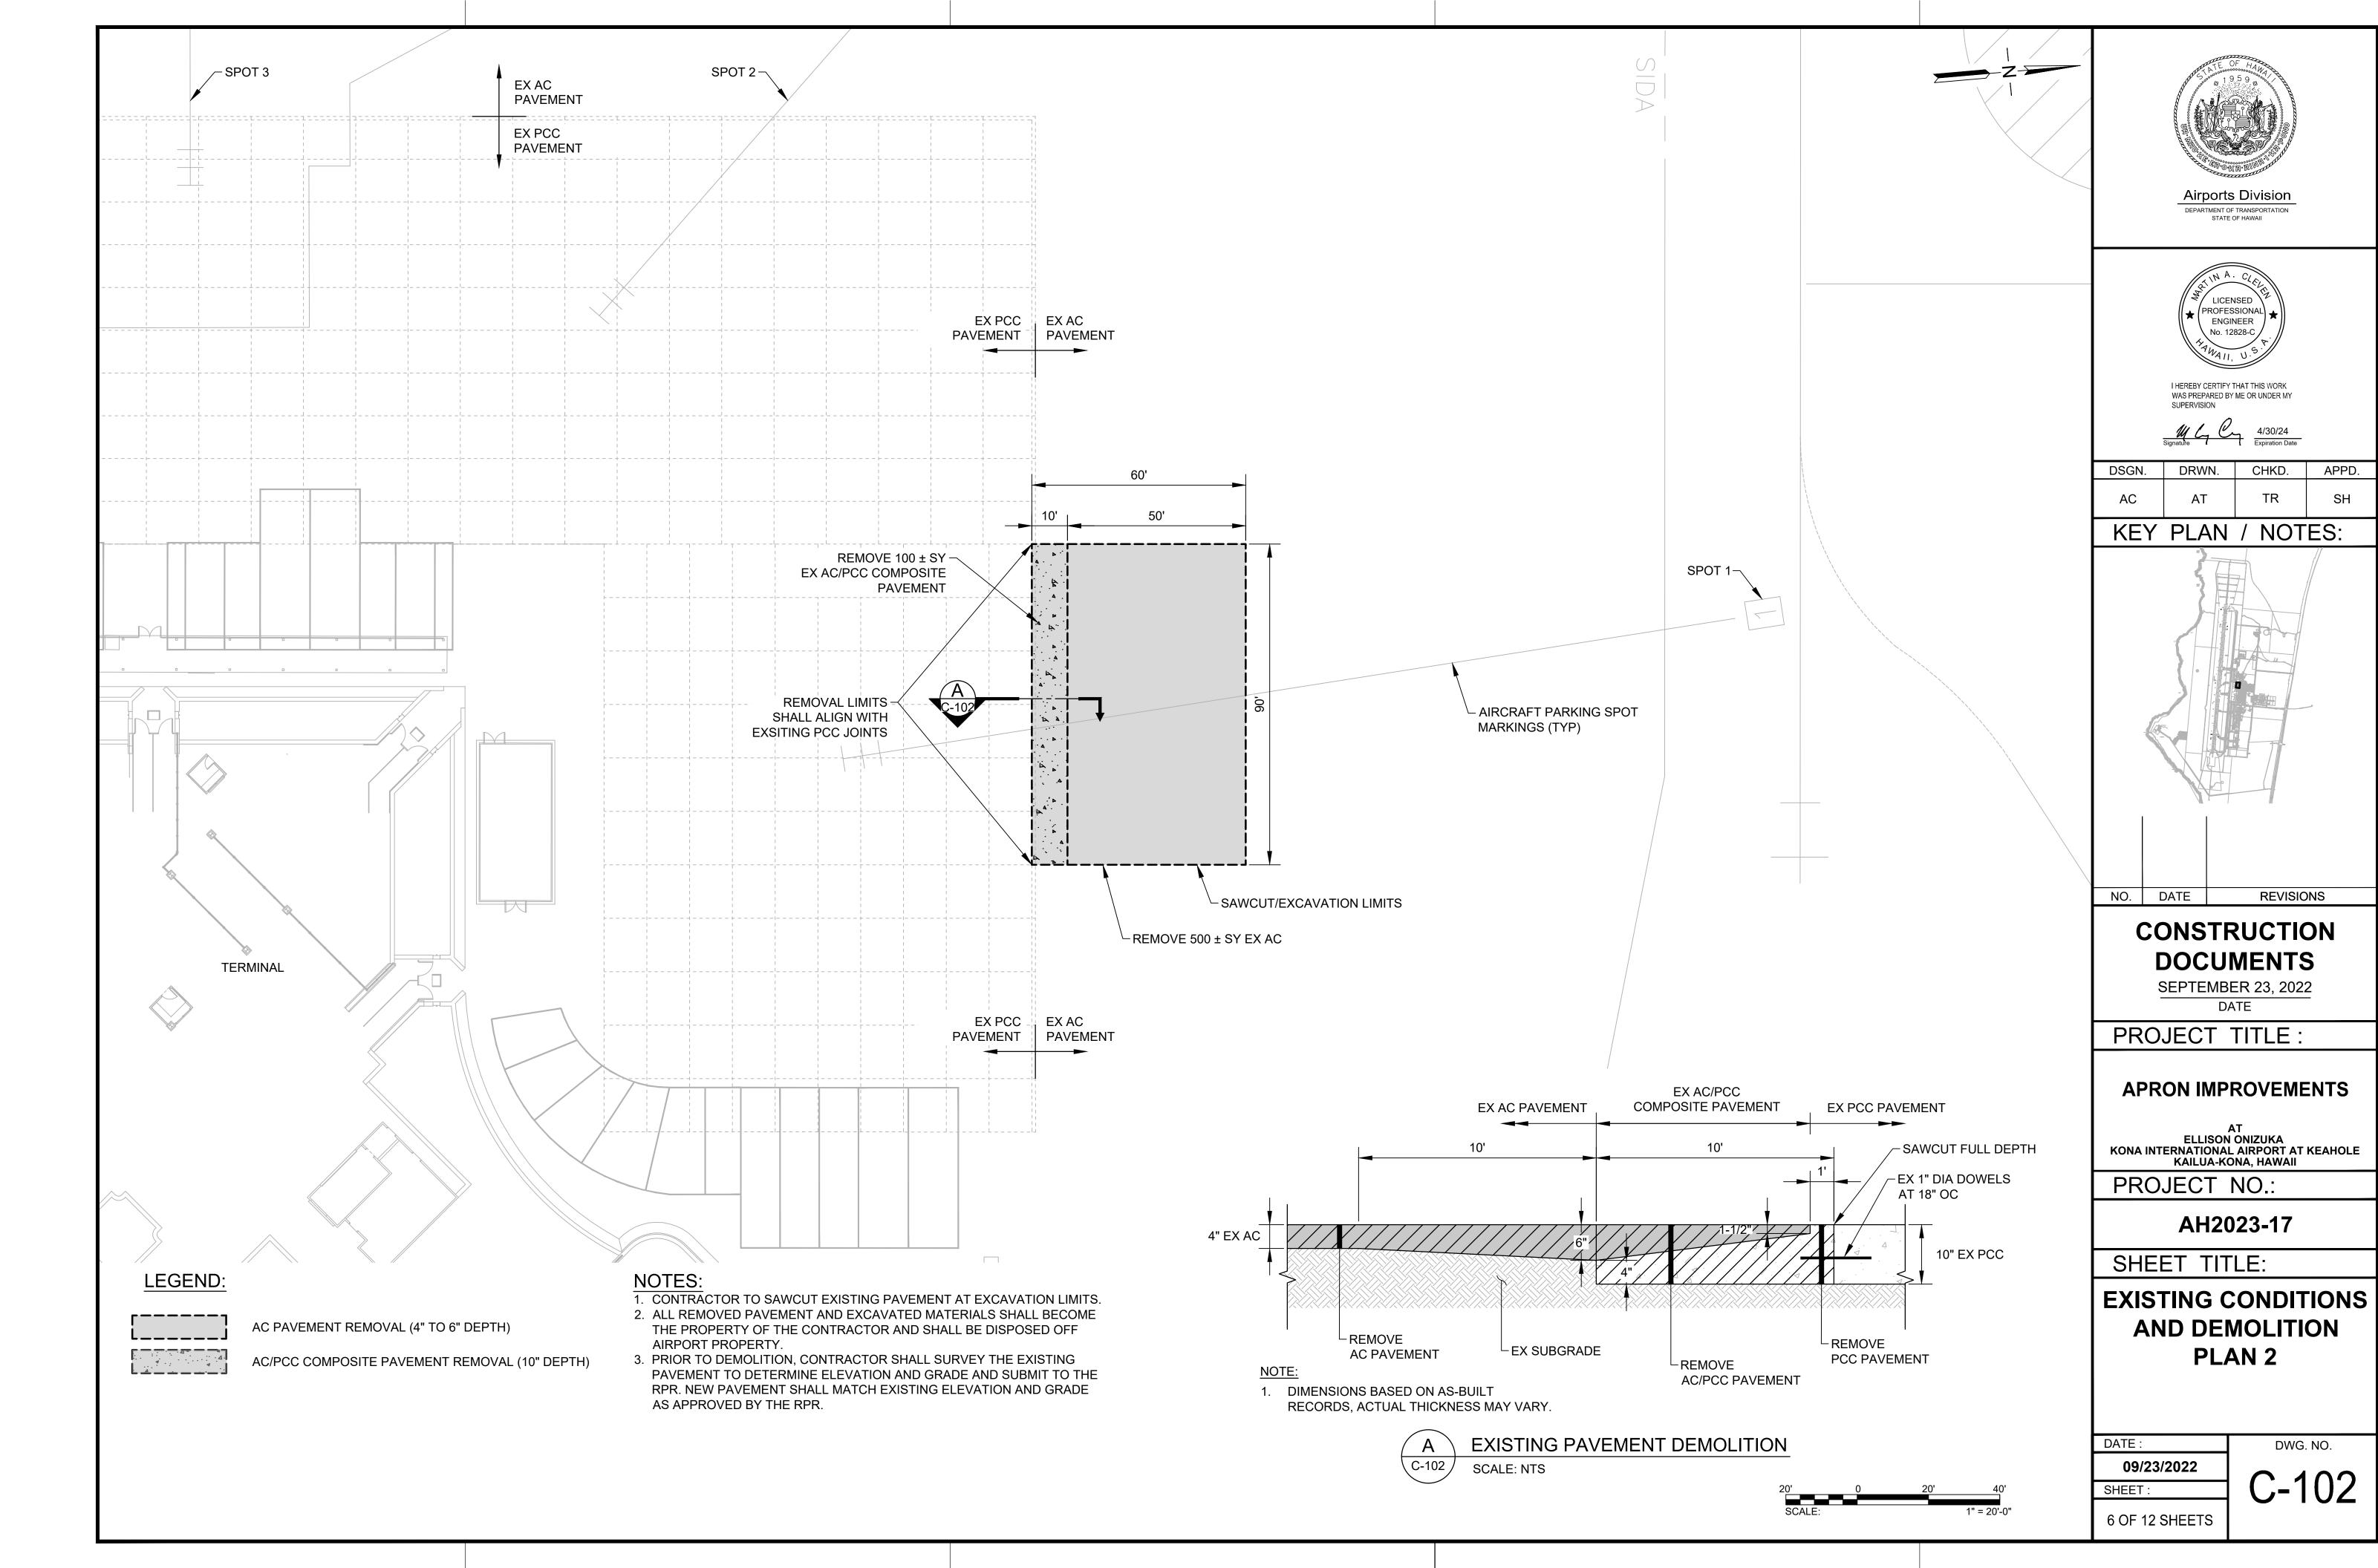
2 OF 12 SHEETS

G-102










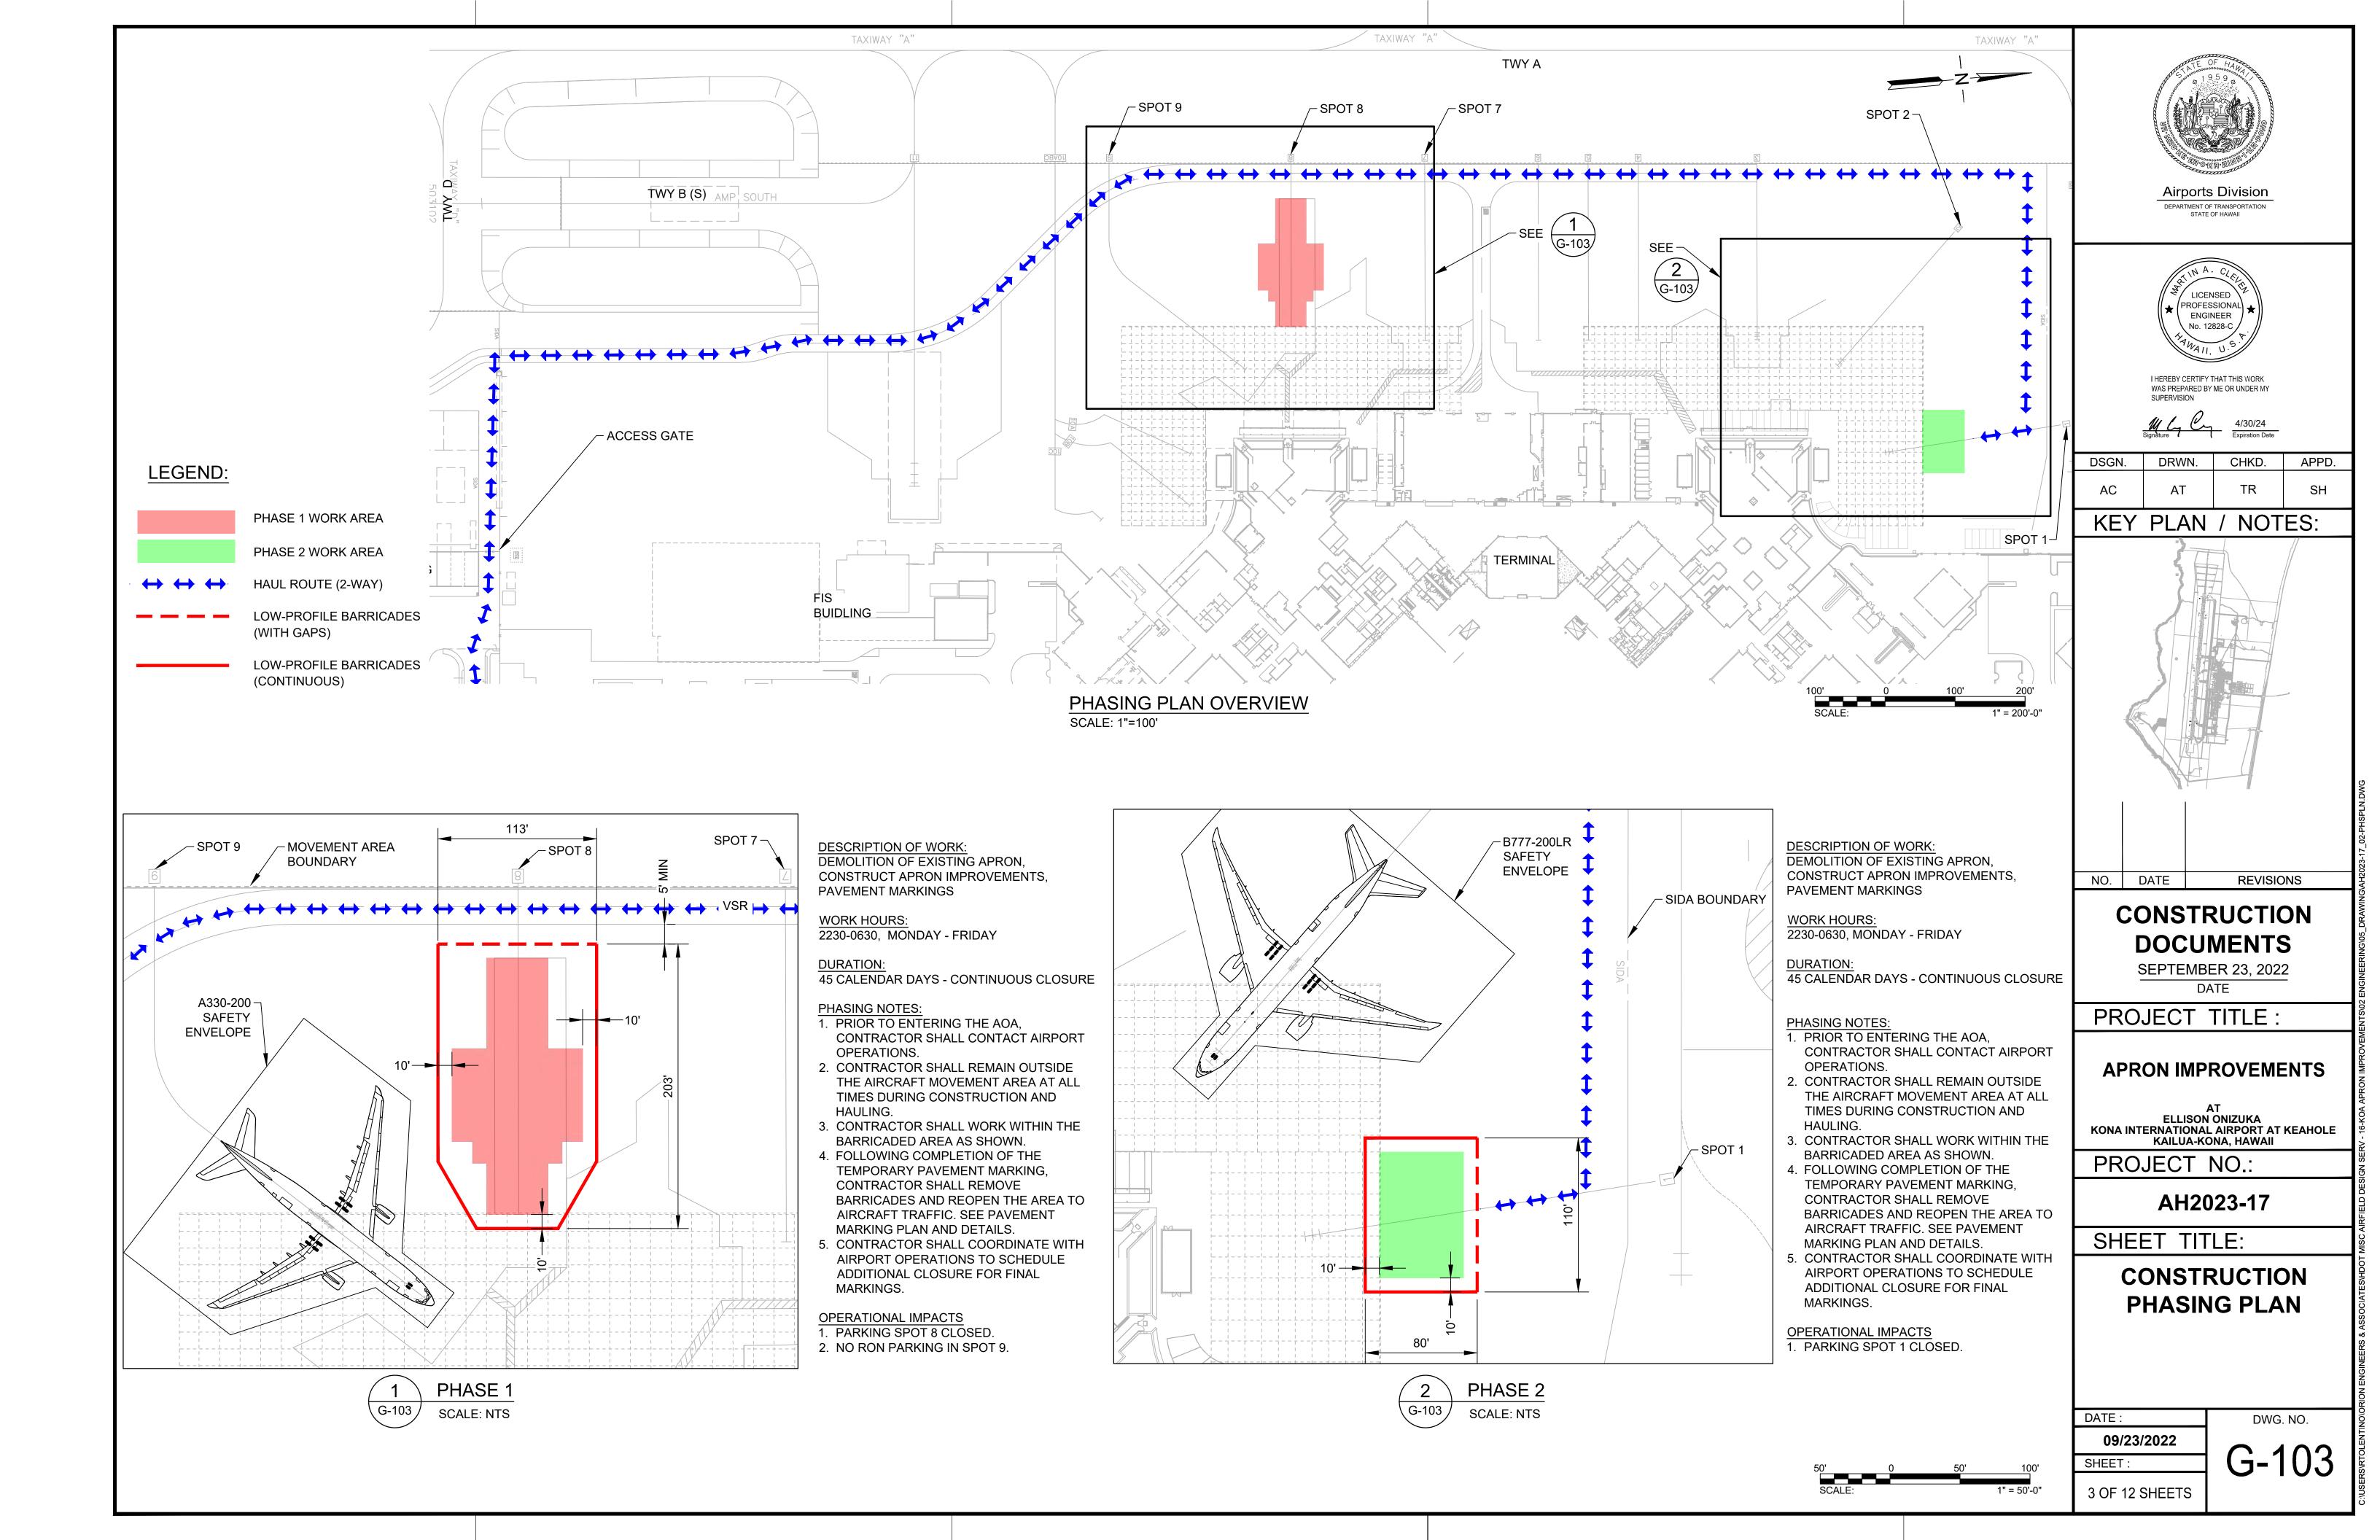

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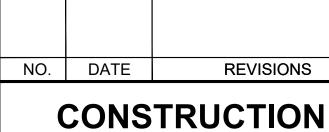
Airports Division DEPARTMENT OF TRANSPORTATION STATE OF HAWAII

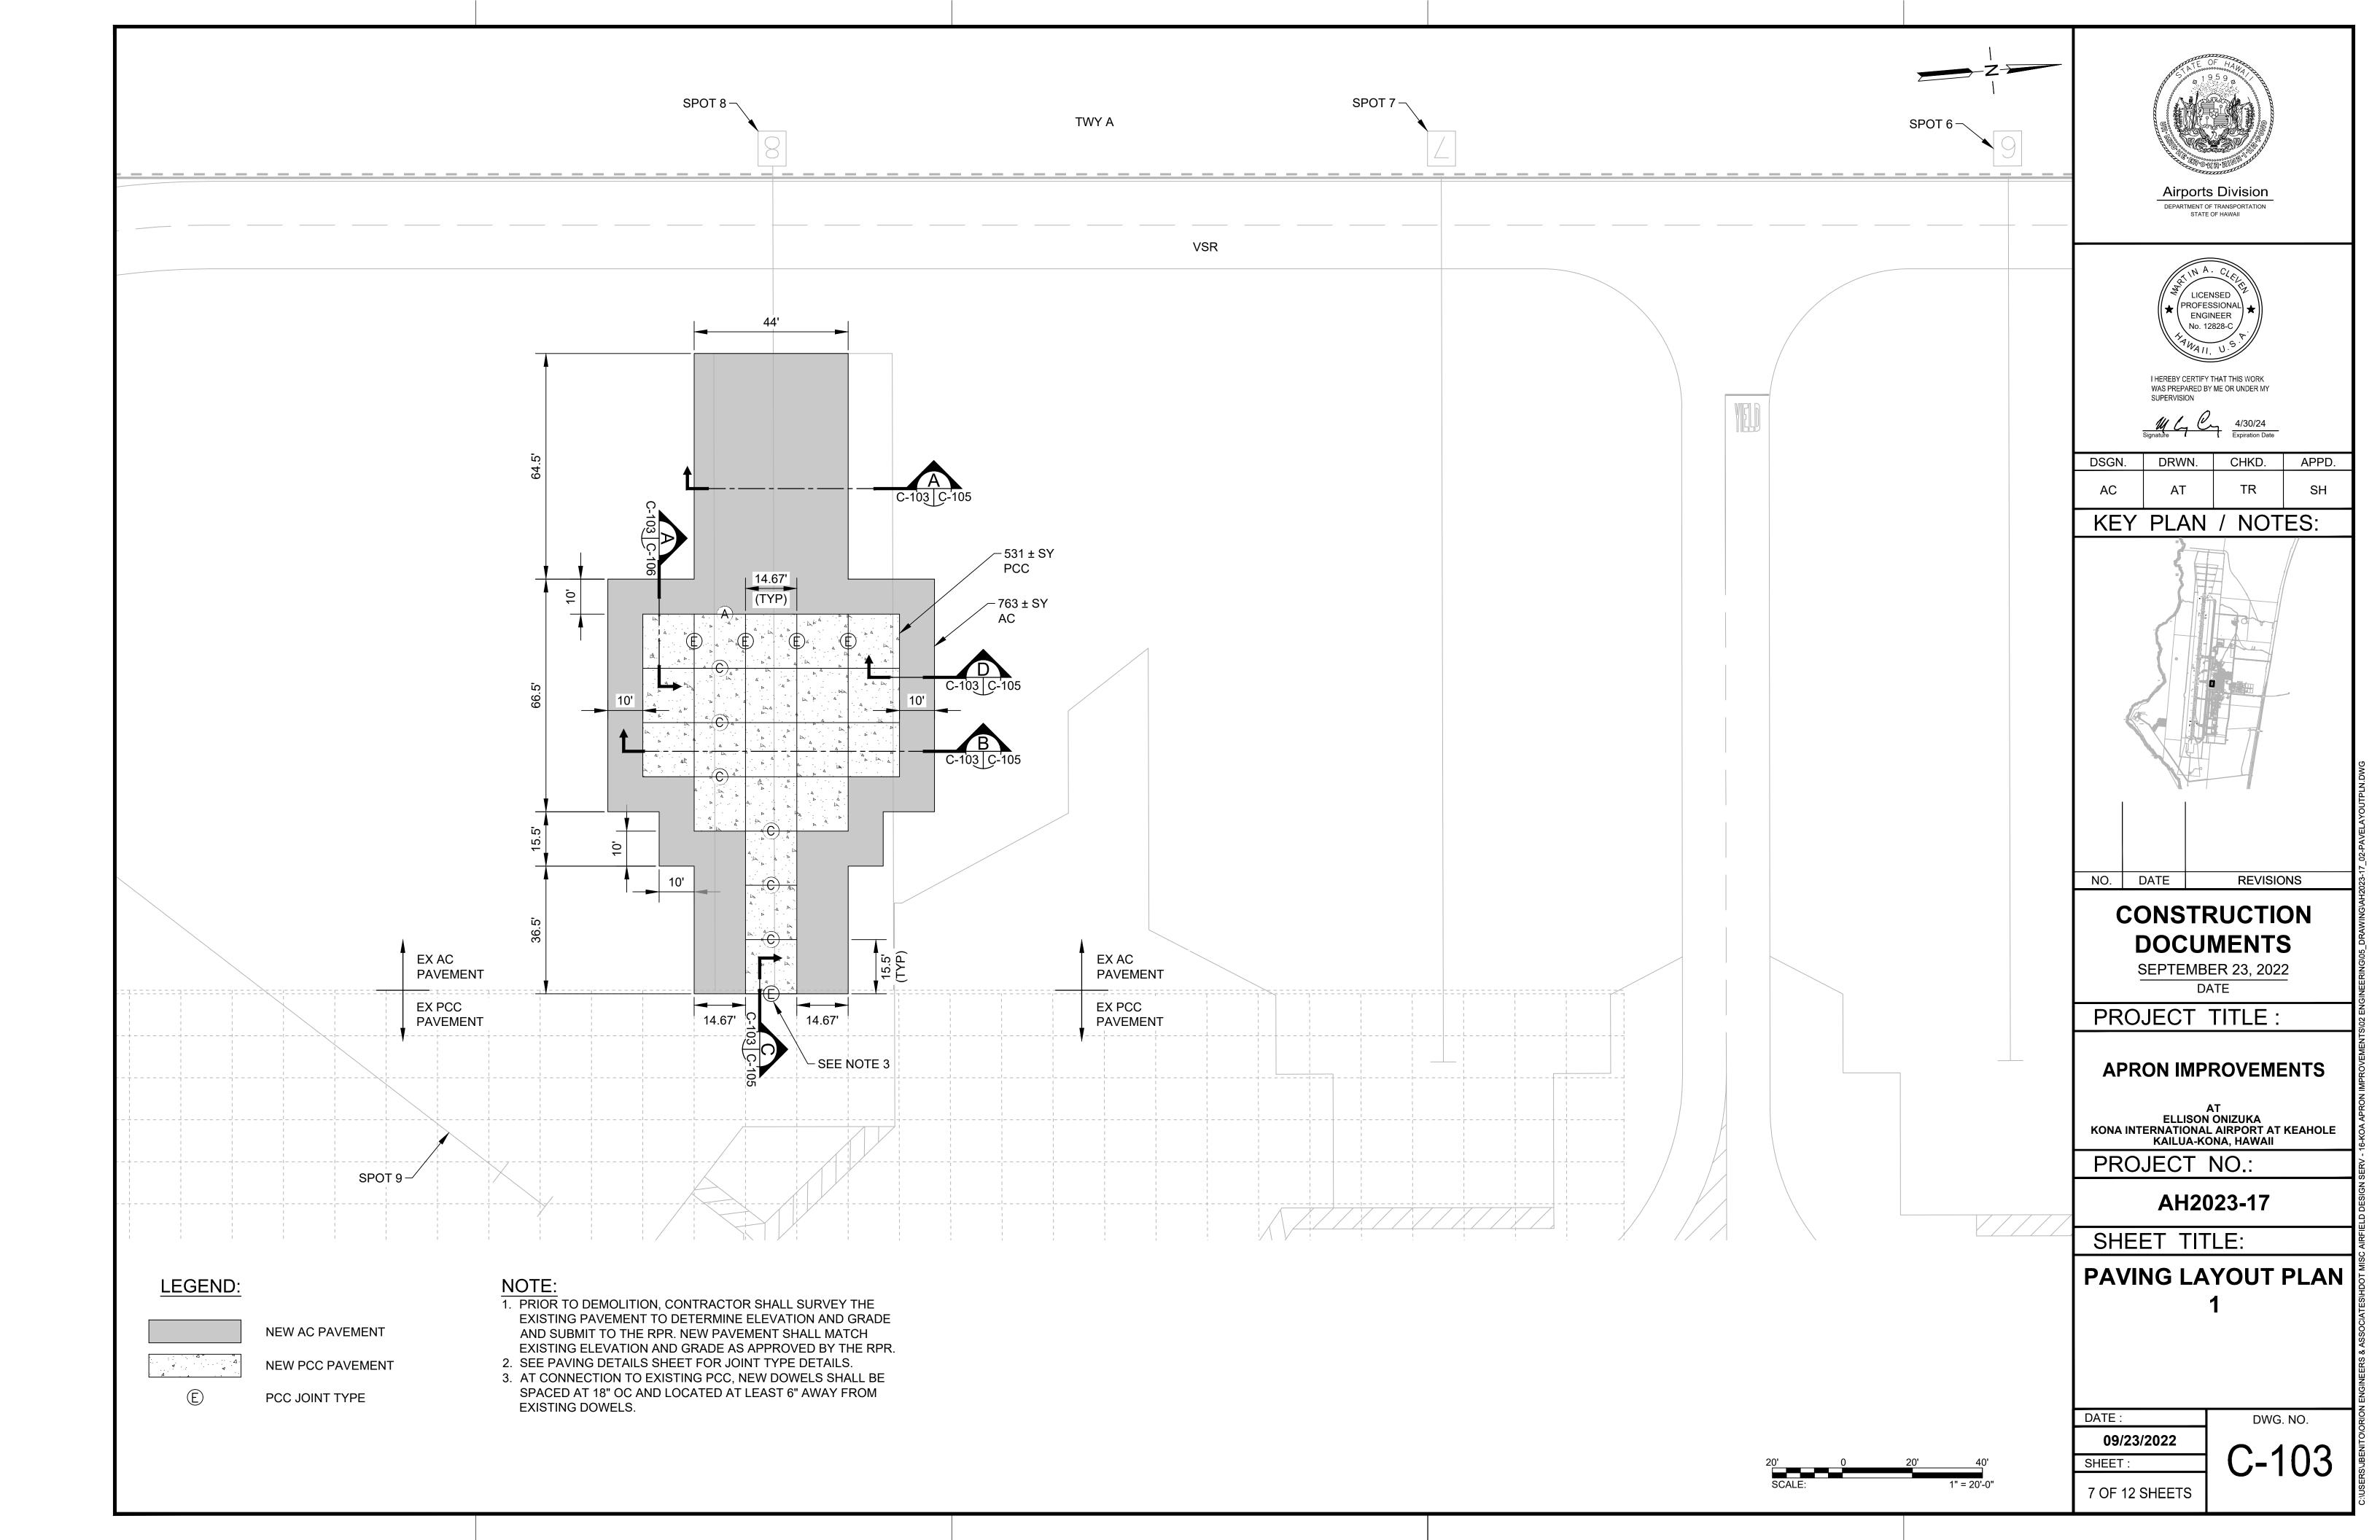
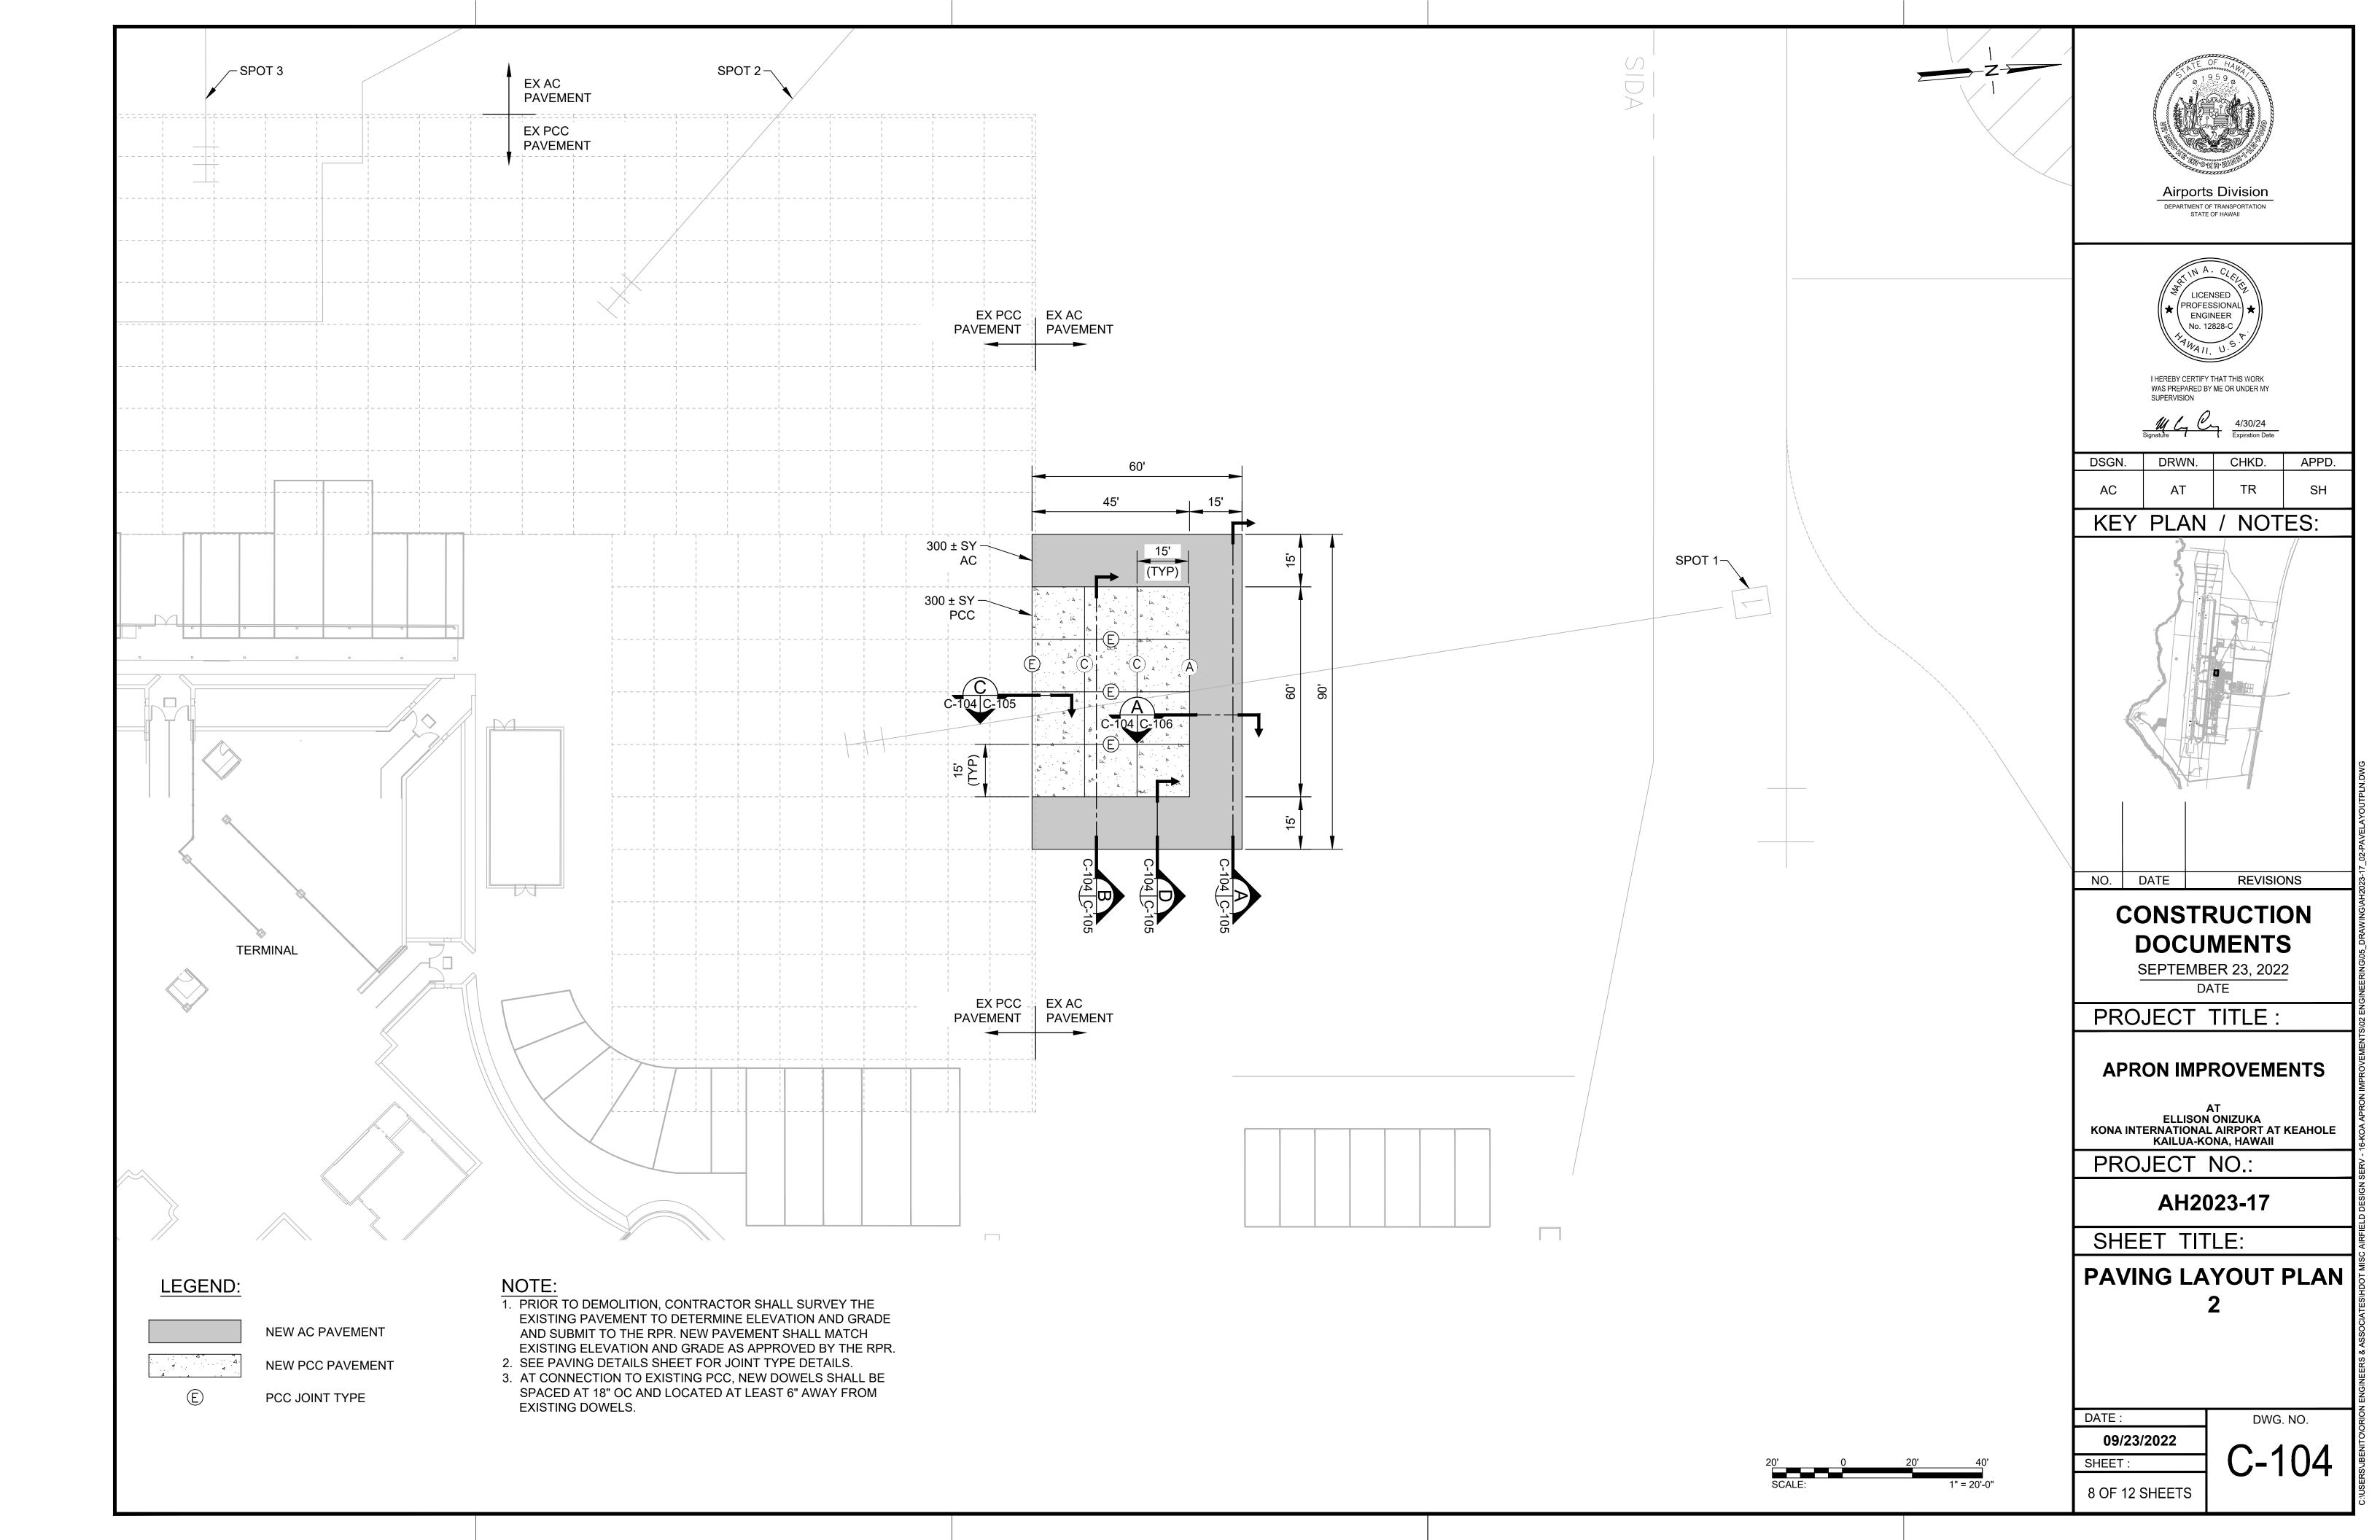
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AC	АТ	TR	SH
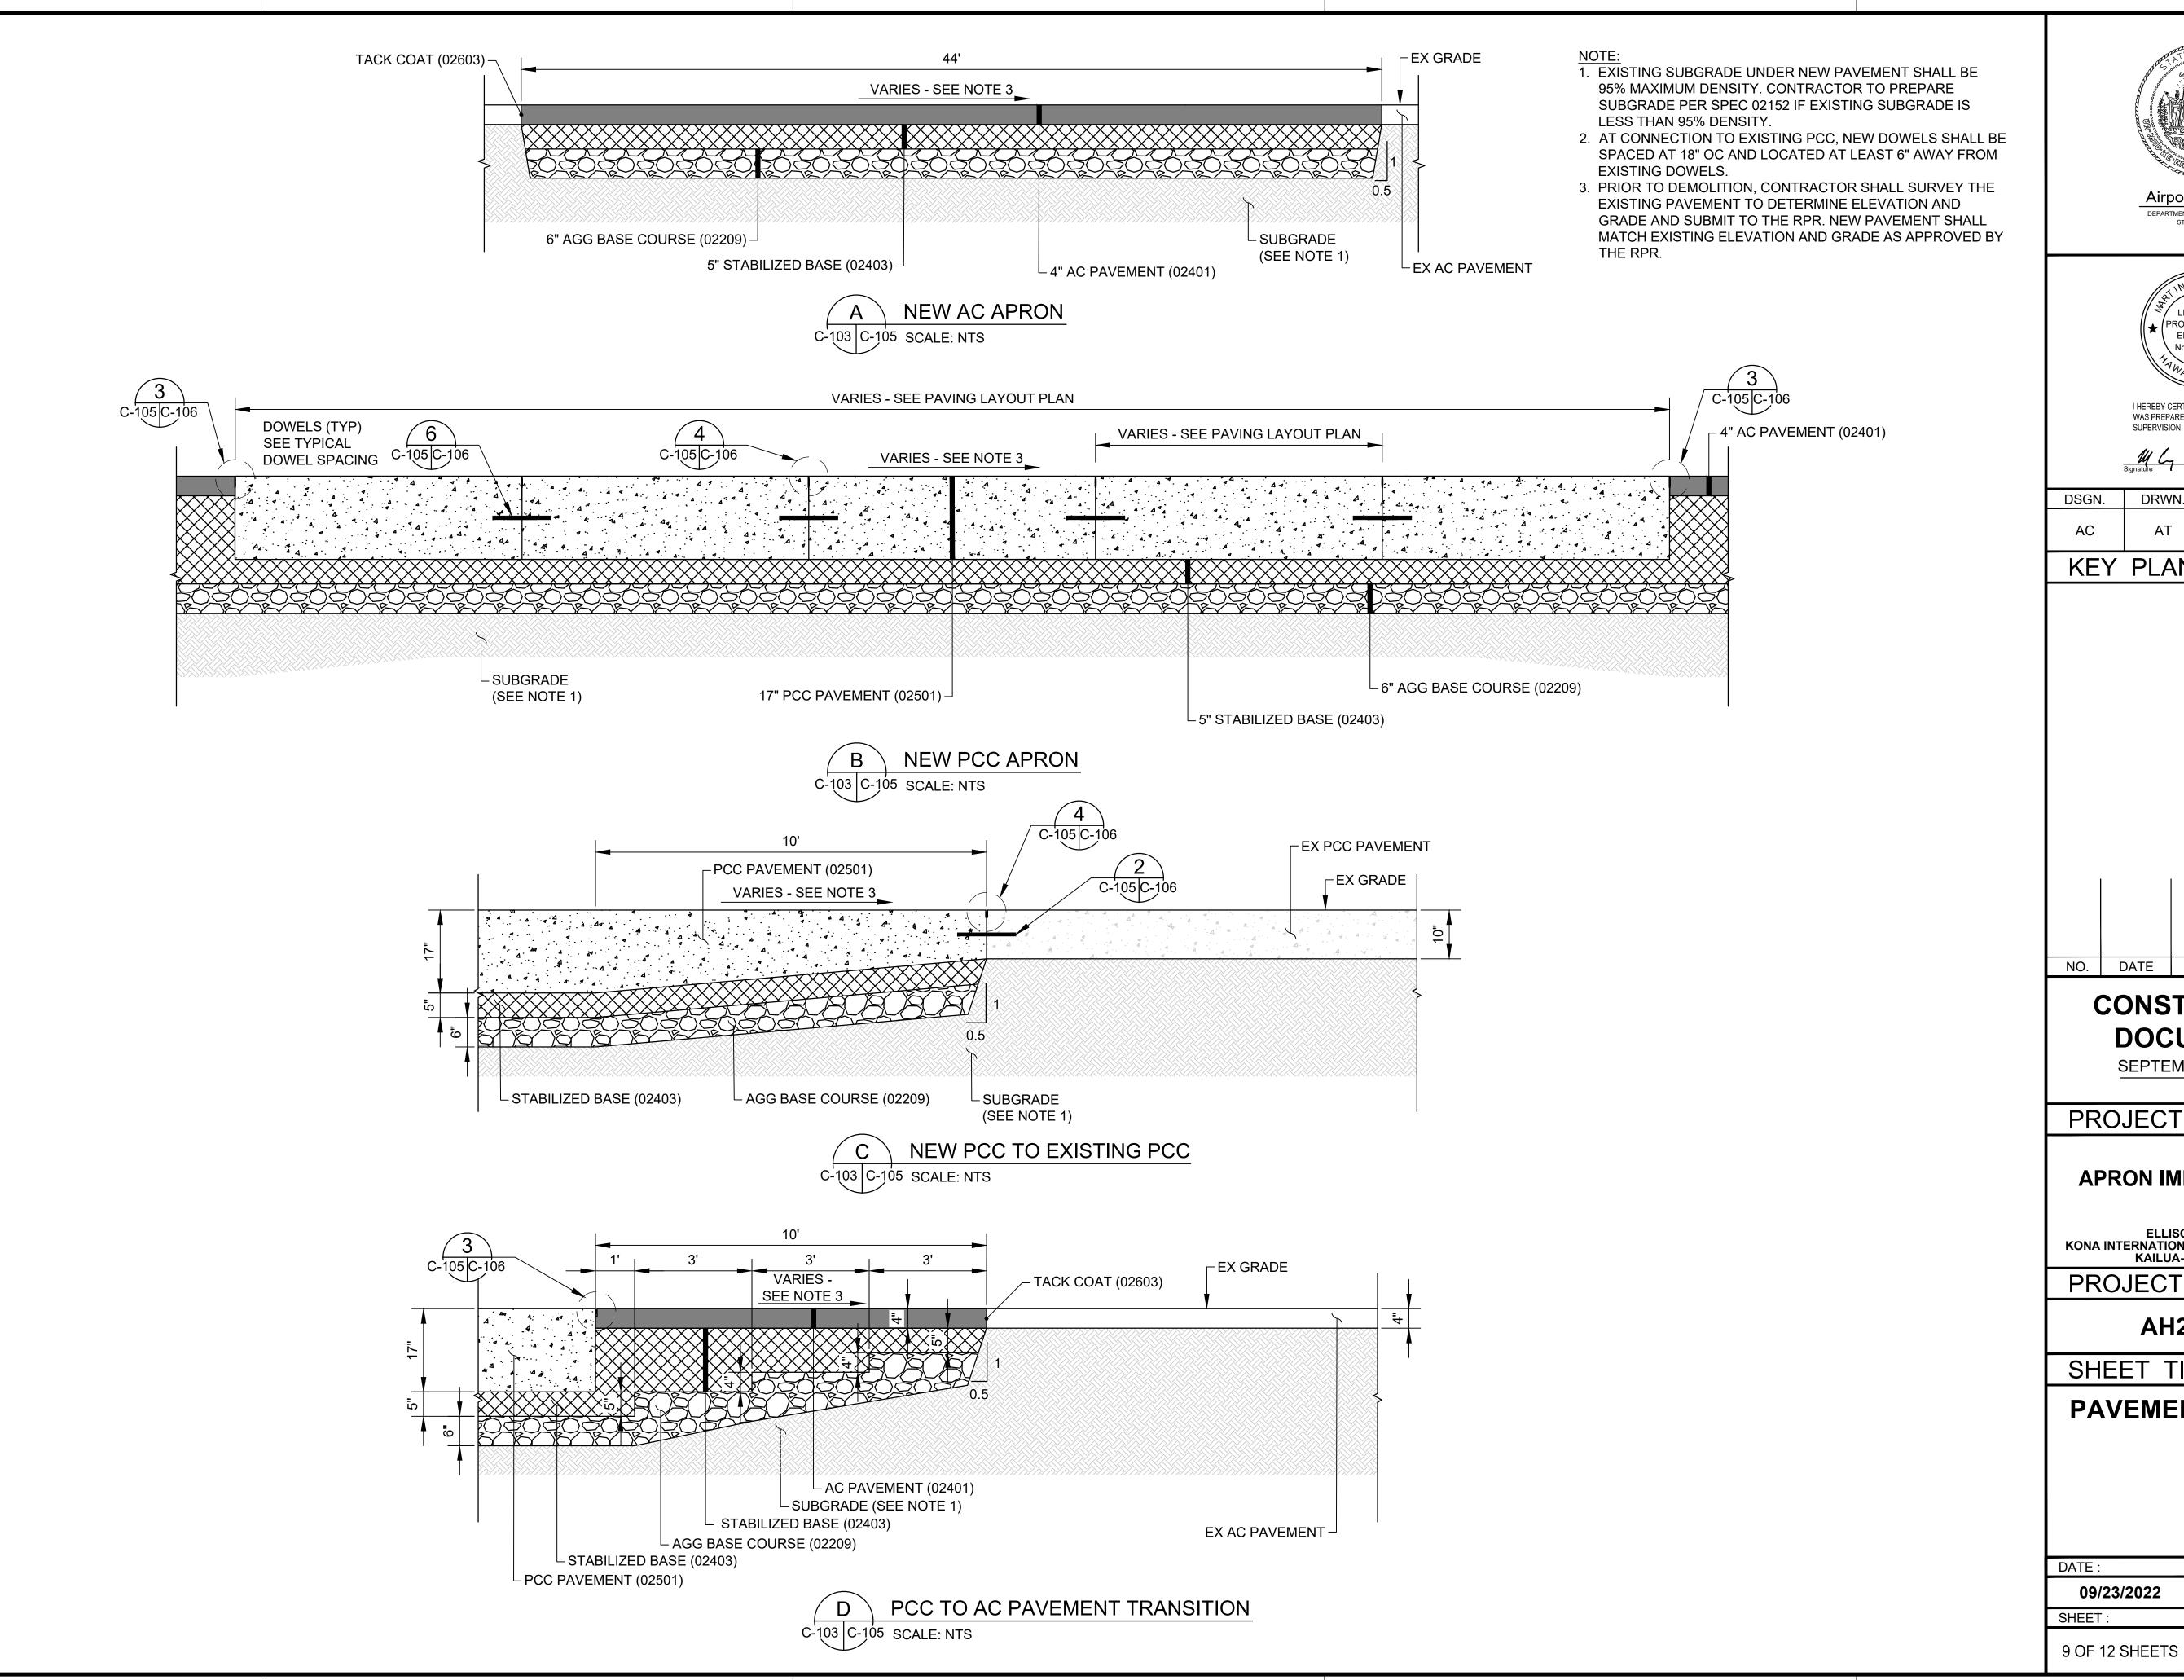
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DOCUMENTS SEPTEMBER 23, 2022

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APRON IMPROVEMENTS

AT ELLISON ONIZUKA KONA INTERNATIONAL AIRPORT AT KEAHOLE KAILUA-KONA, HAWAII

PROJECT NO.:

AH2023-17


SHEET TITLE:

PAVEMENT SECTION

DATE :	
09/23/2022	

C-105

DWG. NO.

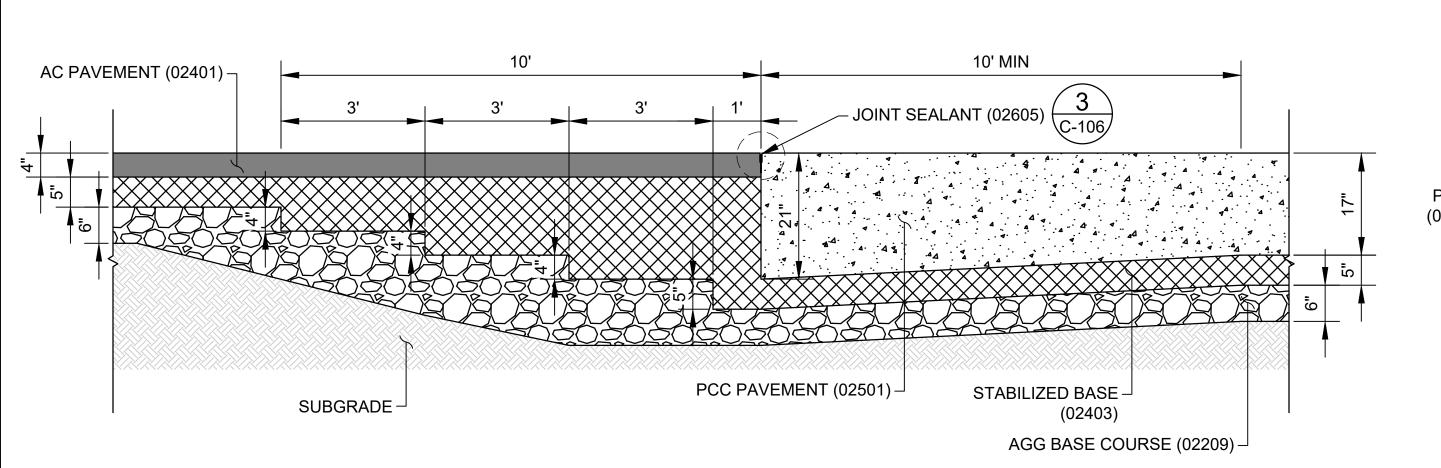



1/2" SAW

CUT

SEALANT


- HOT MIX ASPHALT PAVEMENT (02401)

SPACER BARS


5/8" DIA BACKER ROD -

C-105, C-106 | C-106 | SCALE: NTS


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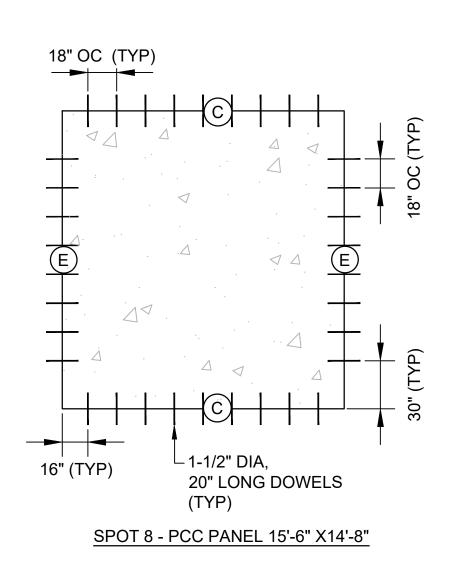


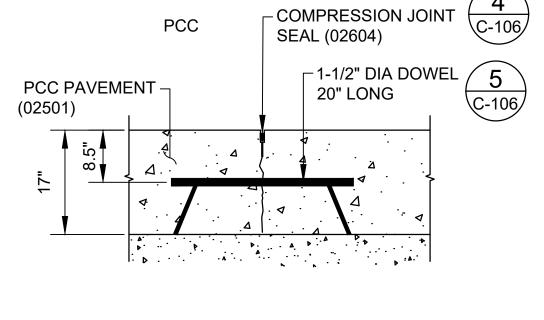




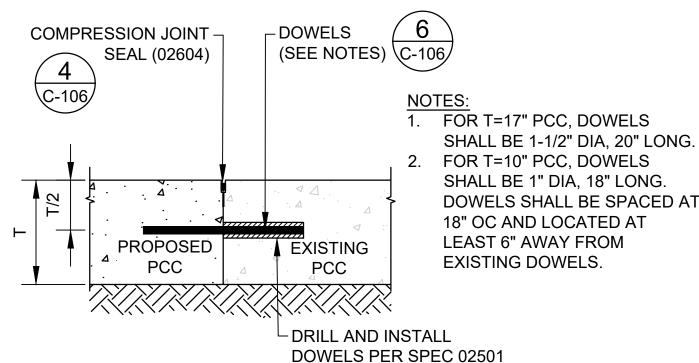




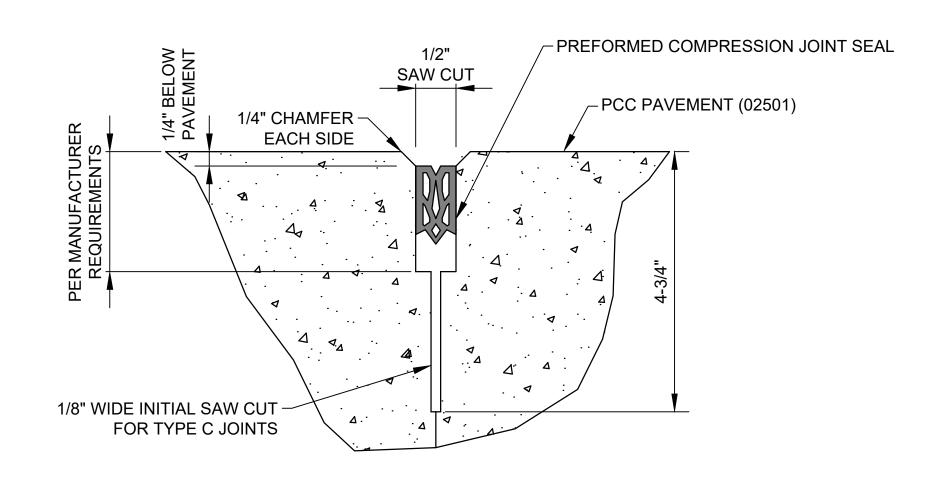

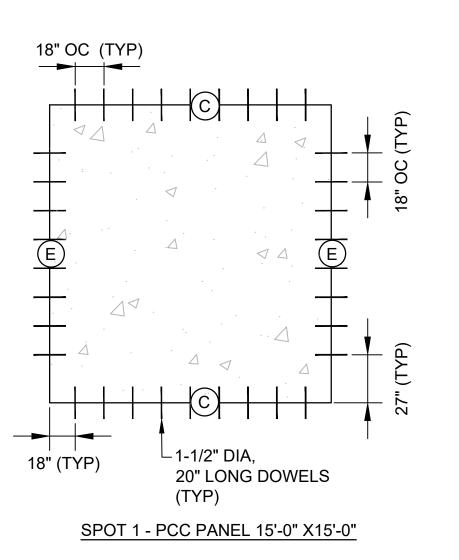



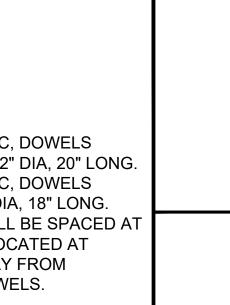




Airports Division DEPARTMENT OF TRANSPORTATION STATE OF HAWAII

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AC	AT	TR	SH

KEY PLAN / NOTES:

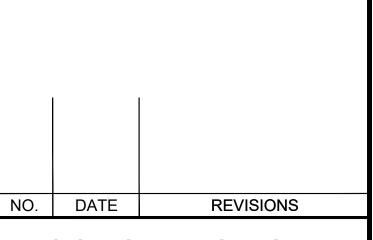

CONSTRUCTION **DOCUMENTS**

SEPTEMBER 23, 2022

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APRON IMPROVEMENTS

AT ELLISON ONIZUKA KONA INTERNATIONAL AIRPORT AT KEAHOLE KAILUA-KONA, HAWAII

PROJECT NO.:


AH2023-17

SHEET TITLE:

PAVING DETAILS


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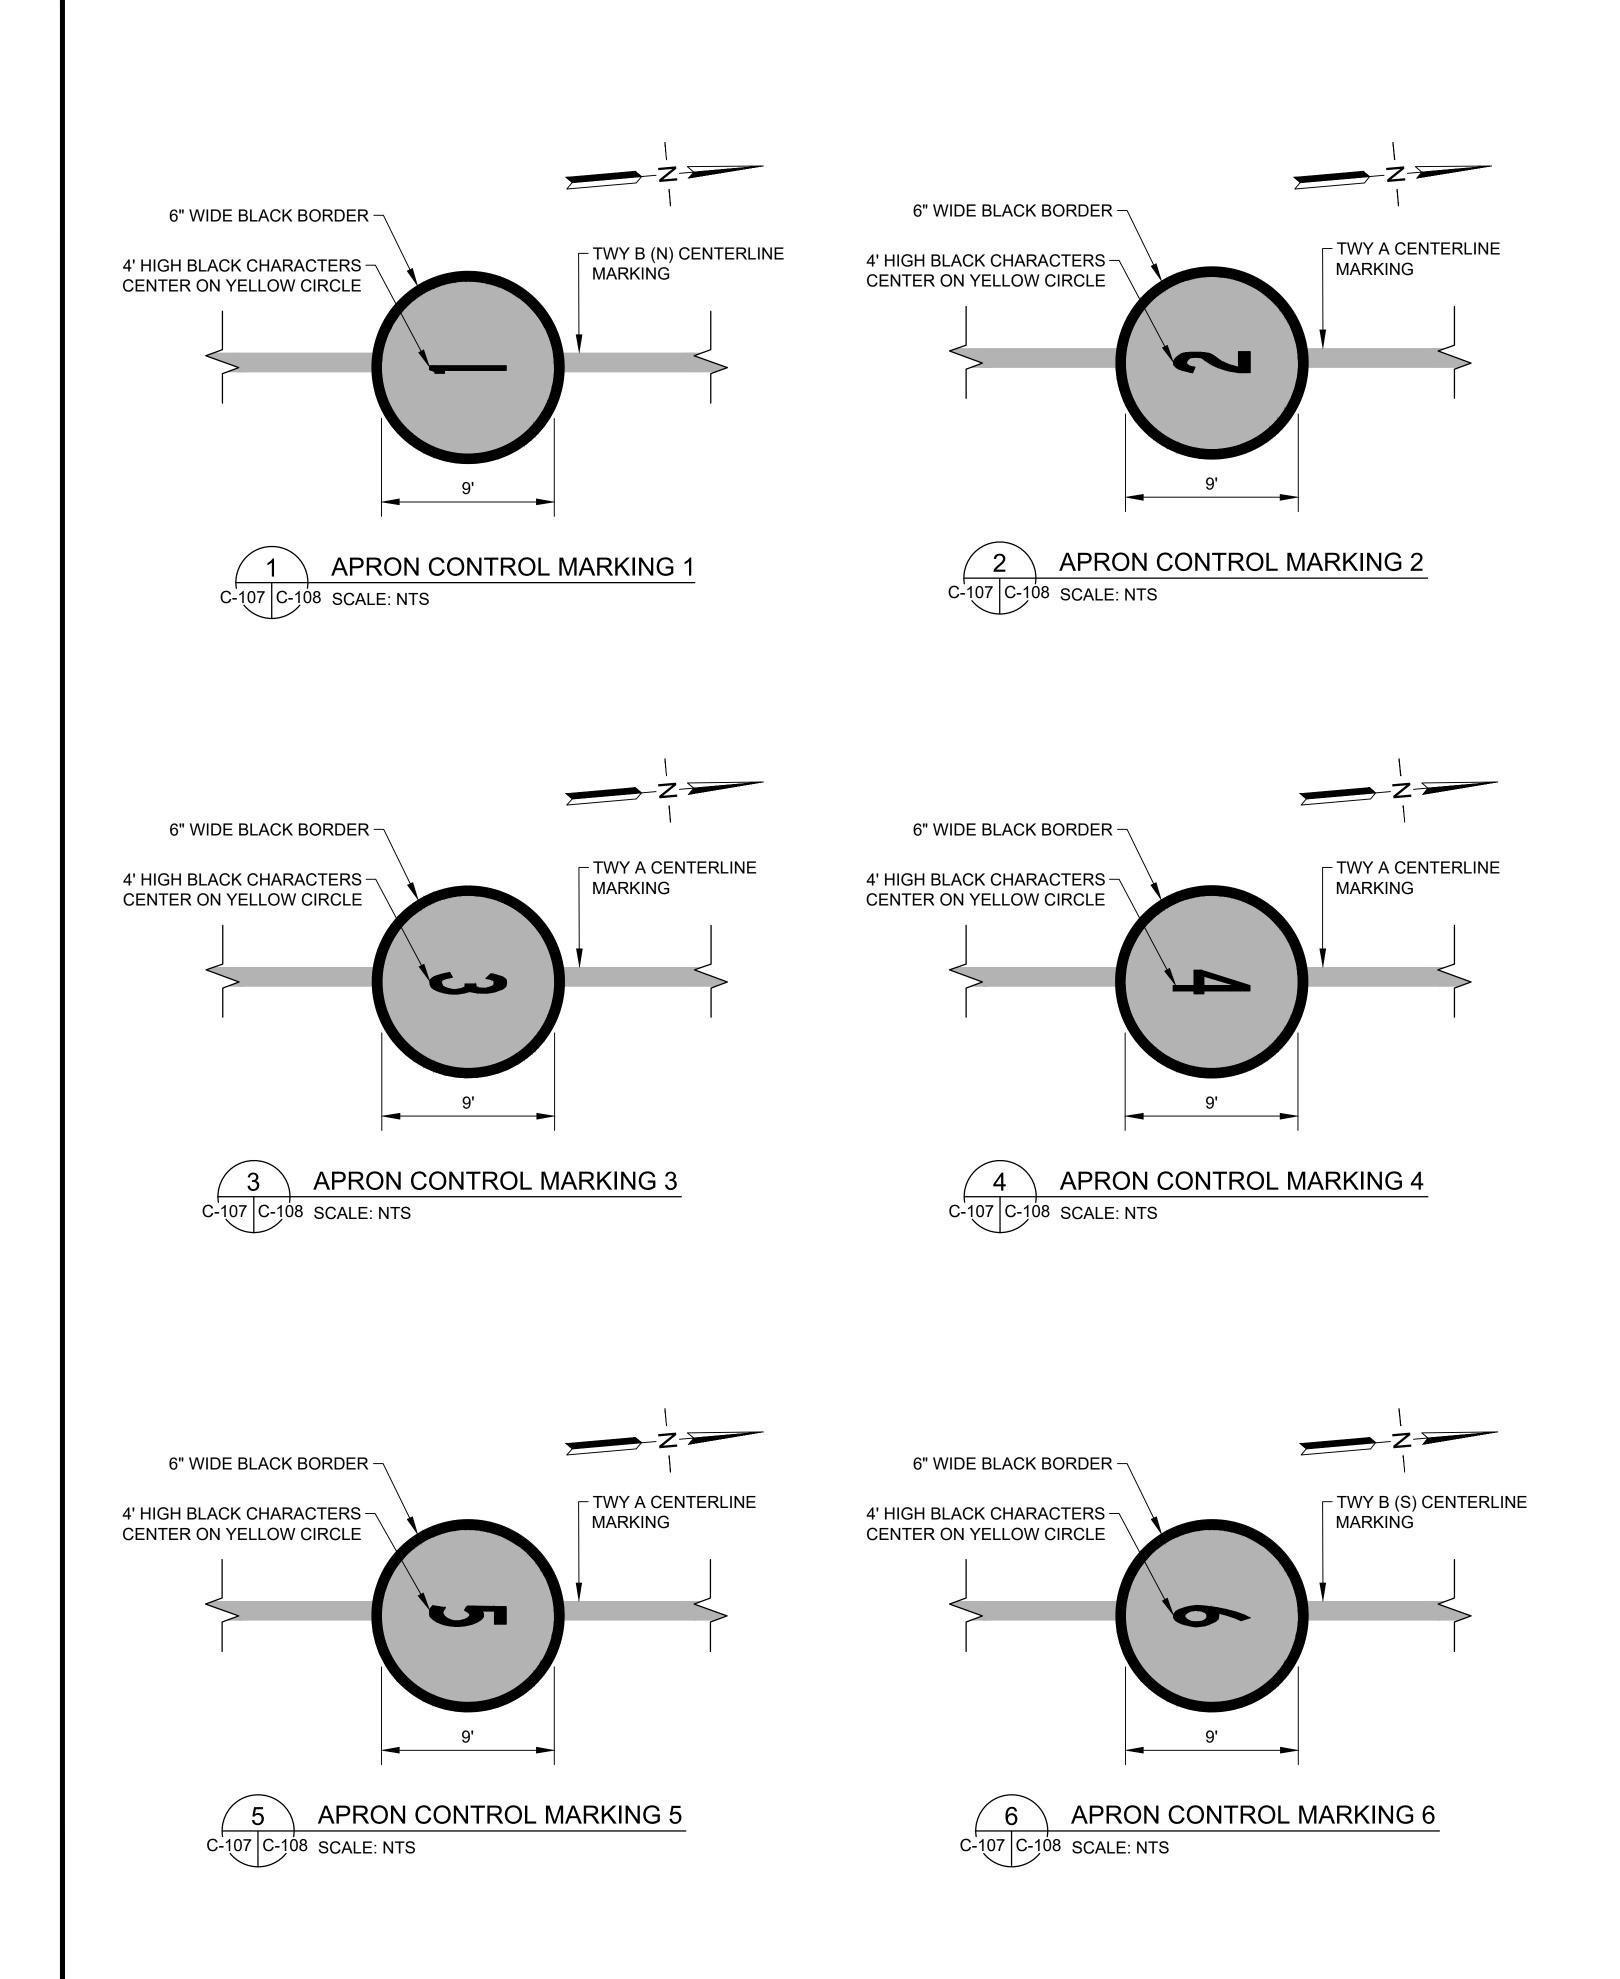
C-106 SHEET: 10 OF 12 SHEETS

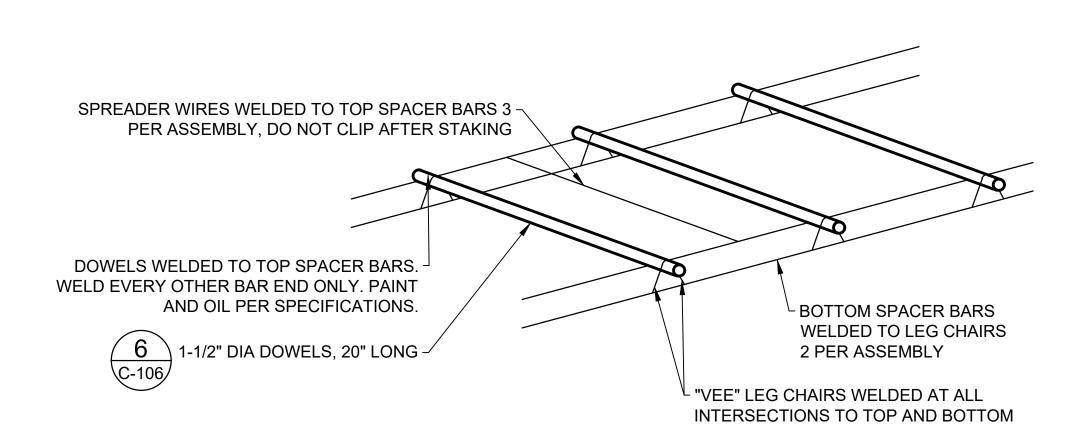



JOINT SEALANT DETAIL

TYPICAL DOWEL ASSEMBLY C-106 SCALE: NTS



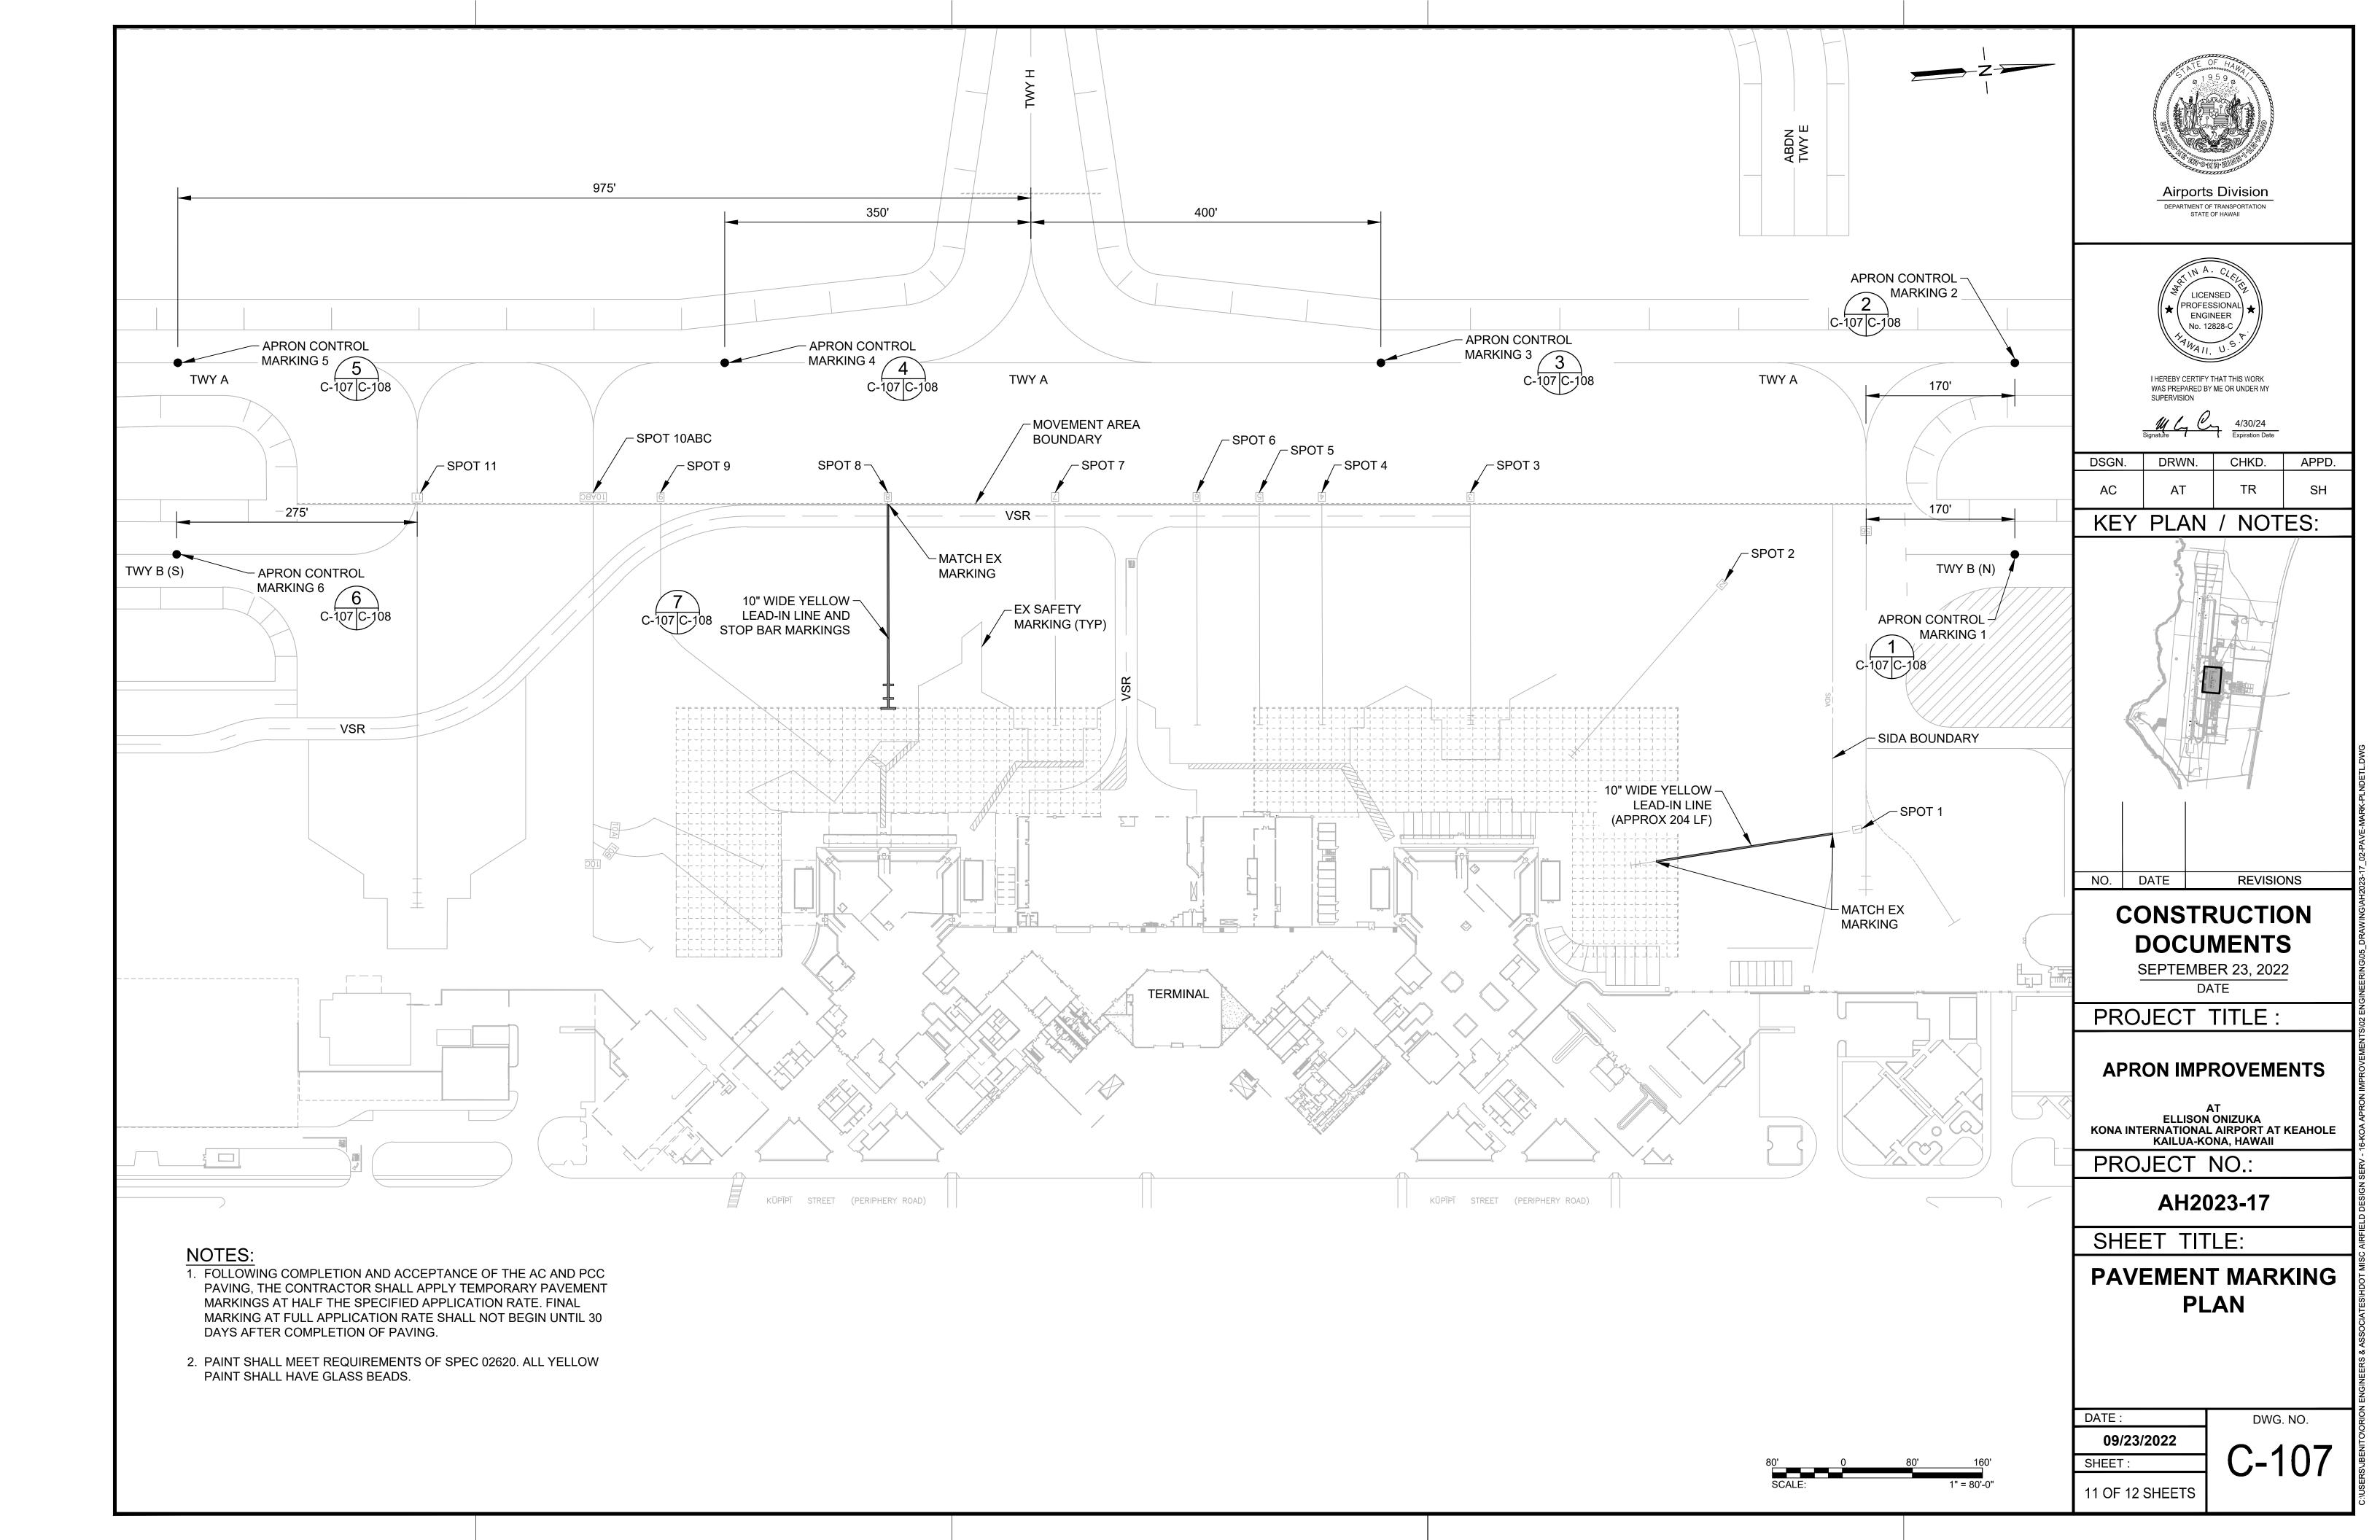

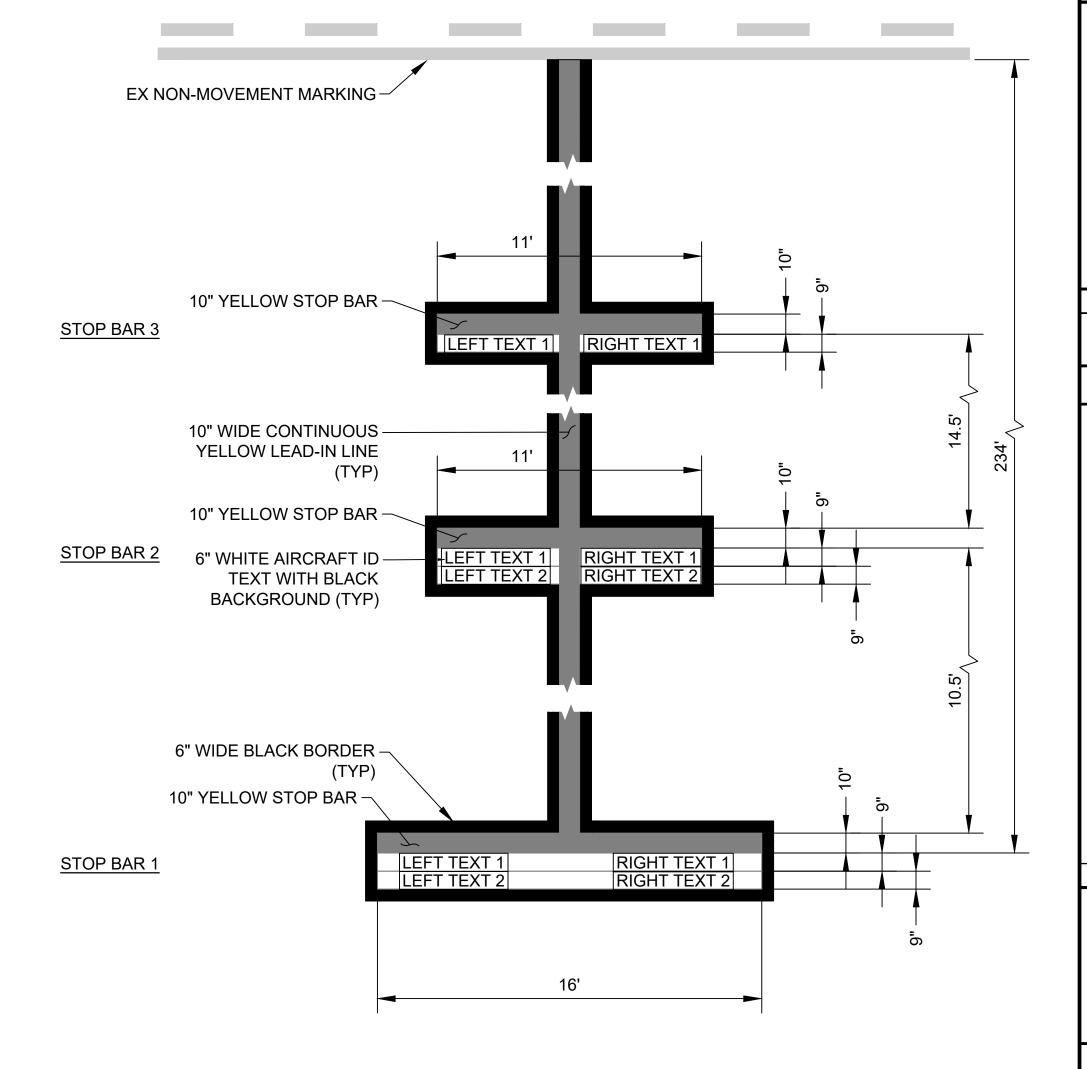


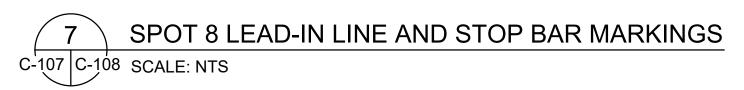

	STOP BAR	LEFT TEXT 1	LEFT TEXT 2	RIGHT TEXT 1	RIGHT TEXT 2
I	1	717-200	767-400ER	A321-200/NEO	
	2	737-700/MAX 7	737-800/900/ MAX 8/9	757-300	767-300ER
	3	A330-200		787-8/9	

NOTE:

1. CONTRACTOR SHALL PAINT 6-IN HIGH AIRCRAFT STOP BAR ALPHABETS AND NUMERALS ON 9-IN BLACK STOP BAR BORDERS AS SHOWN IN TABLE. AIRCRAFT STOP BAR ALPHABETS AND NUMERALS SHALL BE SIMILAR IN FONT STYLE TO "C.H. HANSEN BRASS INTERLOCKING" STENCILS. STENCILS SHALL BE APPROVED BY AIRPORT OPERATIONS PRIOR TO PAINTING.

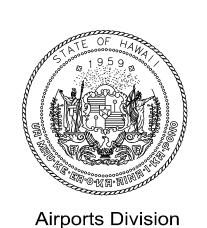

DEPARTMENT OF TRANSPORTATION STATE OF HAWAII



I HEREBY CERTIFY THAT THIS WORK WAS PREPARED BY ME OR UNDER MY

4 C 4/30/24 Expiration Date

DSGN.	DRWN.	CHKD.	APPD.
AC	AT	TR	SH

KEY PLAN / NOTES:



CONSTRUCTION DOCUMENTS

SEPTEMBER 23, 2022 DATE

PROJECT TITLE:

APRON IMPROVEMENTS

AT ELLISON ONIZUKA KONA INTERNATIONAL AIRPORT AT KEAHOLE KAILUA-KONA, HAWAII

PROJECT NO.:

AH2023-17

SHEET TITLE:

PAVEMENT MARKING DETAILS

DATE:	
09/23/2022	
SHEET:	
12 OF 12 SHEETS	

C-108

DWG. NO.